Waimakariri District Council 215 High Street Private Bag 1005 Rangiora 7440, New Zealand Phone 0800 965 468

BC No: 221027

SITE DETAILS:

5 PRICE PLACE

KAIAPOI

LEGAL:

LOT 183 DP 576930

Approved Building Consent Documents and Plans (Full set)

On Site Copy

These plans and specifications must be kept on site during construction, and made available to the building officer on request. Failure to do so will mean an automatic failure of the building inspection and will necessitate re-booking the inspection at the applicant's expense.

• All boundary survey pegs must be located and flagged by the owner before work is commenced.

Inspections

For bookings or building enquiries please phone the Building Unit on:

03 311 8906

or

Email inspection bookings to: bcbooking@wmk.govt.nz

- Please refer to your inspection schedule for details of inspections to be carried out.
- At least 2-3 full working days' notice should be given when booking an inspection.
- Please be advised that it may not always be possible to carry out the inspection within the time frame you require.
- Provision is to be made to allow access.
- The Code Compliance Certificate will be issued once the:
 - Final inspection has been carried out and passed.
 - Audit of WDC building consent file has been completed.
 - Payment of any outstanding invoices is received.





■ A U C K L A N D - P H: (09) 37

RISTCHURCH – PH: (03)

WATSON & LUNDY HOUSE LOT 183 BEACH GROVE

KAIAPOI

RIBRAFT DRAWINGS

Sheet Register							
Sheet	Rev.	Name					
S1		General Notes					
S2		Ribraft Layout Foundation Plan					
S3		Typical Foundation Sections					
S4		Typical Foundation Sections					
S5		Typical Foundation Sections					
S6		Typical Foundation Sections					
S7		Typical Services Penetration Details					

- PH: (03) 3667955



BC221027 WAIMAKARIRI DISTRICT COUNCIL Plans and specifications APPROVED in accordance with the Building Act 2004, clause 49 and the Building Regulations 1992, Clause 3 BC221027 15/09/2022 staceyg



- PH: (03)3667955 E E - MAIL: OFFICE 70 ENGCO, NZ E WWW. ENGCO, NZ



22008.162 File Number

lssue	Register
Date	Description
04.08.2022	Consent Issue

GENERAL

1. These drawings are not to be used for construction until the plan (sheet S2) is signed by the main contractor

2. Do not scale. refer any discrepancies to the Architect/Engineer.

3. These drawings are to be read in conjunction with the Architects & Engineers drawings.

4. The builder shall be responsible for any damage to works during construction.

5. The sand blinding layer shall be 20mm min. & 50mm max. to aid levelling & to prevent rocking of pods.

6. Vapour barrier to be 0.25mm (250 micron) polythene complying with NZS 4229. / NZS 3604

7. Finished ground level adjacent to slab to be protected from wind, water erosion and undermining.

FOUNDATIONS


1. For assumed allowable bearing capacity refer to calculations/installer guide Unless otherwise noted in documentation

2. If there is any doubt about the integrity of the material on which the slab is to be founded - Supervising Engineer must be notified immediately.

GEOTECHNICAL REFERENCE:

Refer: Tonkin + Taylor "Scala Penetrometer testing" Ref. 53246.6001 Dated: 20th May 2022

Confirm Ultimate Bearing Capacity after site stripping > 180 kPa

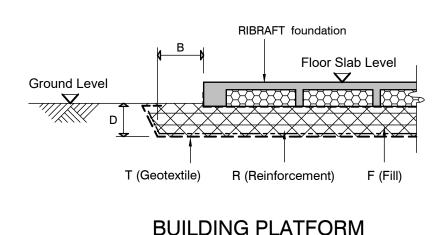

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N.T.S.





CONSENT ISSUED BC221027 - Page 3 of 31

1. All workmanship & materials to conform to NZS 3109, NZS 4210 & local authority regulations.

2. Minimum covers to reinforcement:

CONCRETE

- Exposed to earth 75mm.
- Protected by vapour barrier 50mm.
- Not exposed to weather except for a brief period during construction 25mm.

3. No holes or chases other than those specified are to be made in the slab without the approval of the Engineer.

4. All concrete shall be 20mm nominal maximum aggregate size & 120mm slump & shall comply with NZS 3109.

5. All concrete to be mechanically vibrated & carefully worked around the reinforcement & into the corners of the formwork.

6. Ribraft make-up to be

100mm Floor Slab - 220mm pods (25 MPa TC2 Dramix 4D 80/60 Fibre mix Concrete) G500 E SE62 Ductile mesh on 50mm chairs


The design Fibre mix shall be supplied so that the residual flexural tensile stresses f_{B.1} & f_{B4.K} shall be 1.5 MPa & 1.0 MPa respectively.

INSPECTIONS

Inform ENGCO consulting 48 hours in advance of any inspections required for code compliance certification. Contact ENGCO - Ph. 03 366 7955

INSPECTIONS REQUIRED

- 1. Confirm bearing at excavation by OTHERS
- 2. Contractor to supply (4) x N.D. Tests at mid-height and finished compacted surface. - only if depth of fill is greater than 400mm
- 3. Pre-pour of slab by ENGCO

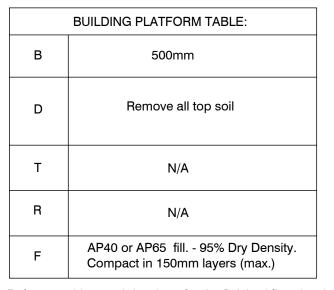

Refer to architectural drawings for the finished floor level



GENERAL NOTES

STEEL

- in grade 300 or grade 500E.
- 2. All bends to be made cold without fracture.

4. Grade 500E deformed bars shall be designated 'H', Grade 300 deformed bars shall be designated 'D' and Grade 300 round bars shall be designated 'R'

5. Minimum bar splice 720mm. (or unless otherwide noted)

6. All reinforcement to be fixed & tied where necessary in its specified position.


- 7. Welding of steel is not permitted
- 8. Spacers:

- Internal one on each side of pod (typically).

requirements exceeding 10%.

WAIMAKARIRI DISTRICT COUNCIL Plans and specifications APPROVED in accordance 10. All Mesh shall lap a minimum of 250mm (end extensions are not included in lap length) with the Building Act 2004, clause 49 and the Building Regulations 1992, Clause 3 BC221027 15/09/2022 staceyg

Provide 2- H12 lapping bars Top & Bottom to all beam corners.

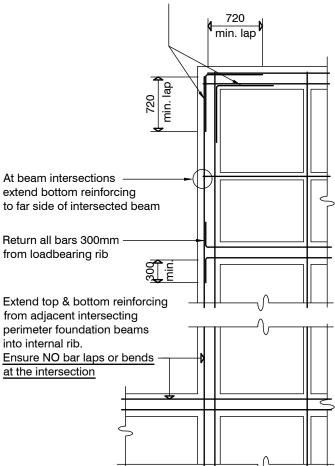


contractor shall verify all dimensions before commencing work

1. All reinforcing shall be New Zealand sourced and conform to AS/NZS 4671 :2001

3. All reinforcing shall be deformed type unless otherwise stated.


- Edge at 1200mm ctrs (one on edge & two on corners, typically).

9. All mesh shall comply with AS/NZS 4671 & shall conform with elongation

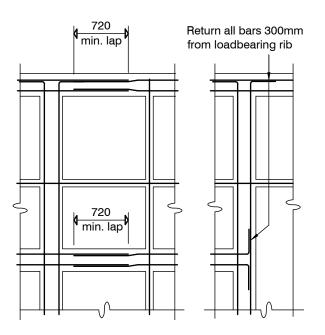

TYPICAL CORNER STEEL & MIN. LAPPING REQUIREMENTS N.T.S.

design K.SYMMES 22008.162 drawn S BLOCKLEY dwg rev. appvd M.CUSIEL S1 date 04.08.2022

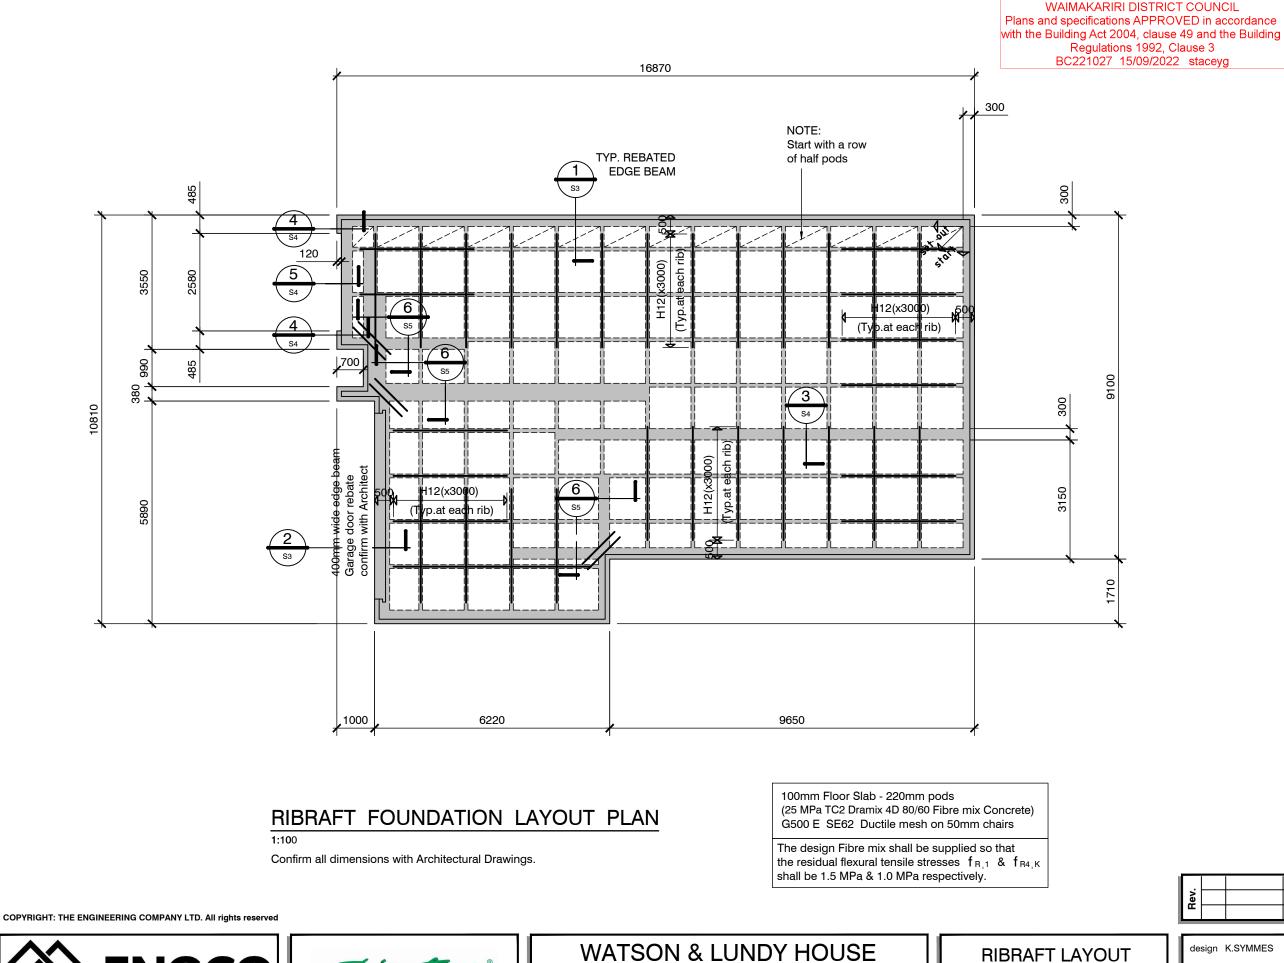

CONSENT ISSUED BC221027 - Page 4 of 31



■ AUCKLAND - PH : (09)3777955 ■ CHRISTCHURCH - PH : (03)3667955 ■ NELSON - PH : (03)3667955 ■ QUEENSTOWN - PH : (03)4424255 ■ E-MAIL : OFFICE @ ENGCO.NZ ■ WWW.ENGCO.NZ ■

OMES

LOT 183 BEACH GROVE

KAIAPOI

contractor shall verify all dimensions before commencing work

GENERAL NOTES:


Locations shown of internal floor beam thickenings are indicative only. It shall be the responsibility of the Contractor to ensure that they are located centrally under the load bearing walls to which they pertain.


Under no circumstance should pipework for services be run longitudinally in 100mm ribs.

Similarly they should not be run along perimeter foundations nor internal floor beam thickenings

Vertical or horizontal penetrations through the foundation edge beam or floor beam thickenings must be made through the middle third of the member. Vertical penetrations should not be made through 100mm ribs.


Refer to Architects drawings for floor slab set downs, steps, rebates, holding down bolts, cast in componentry and the like.

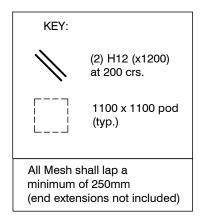

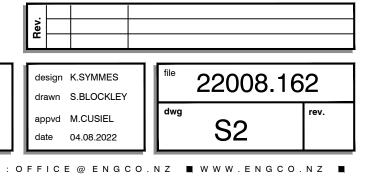



FOUNDATION PLAN

CONSENT ISSUED BC221027 - Page 5 of 31

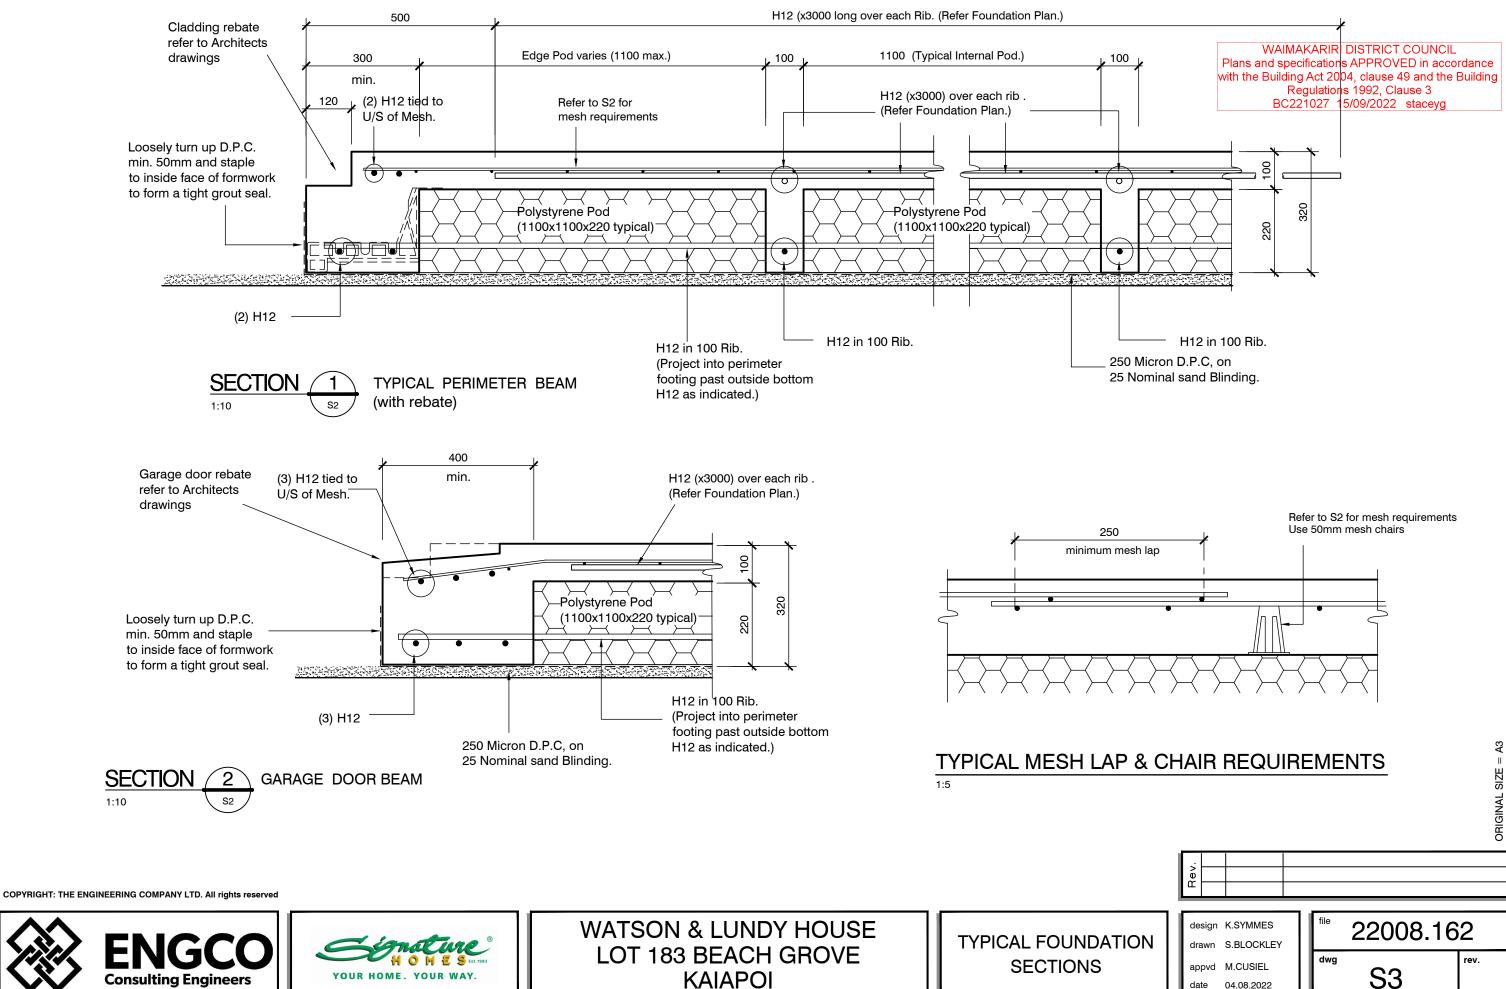



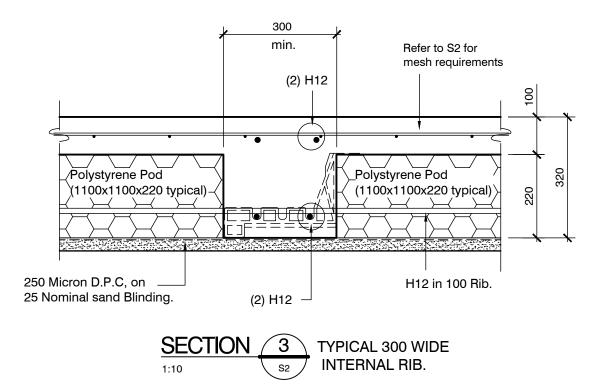

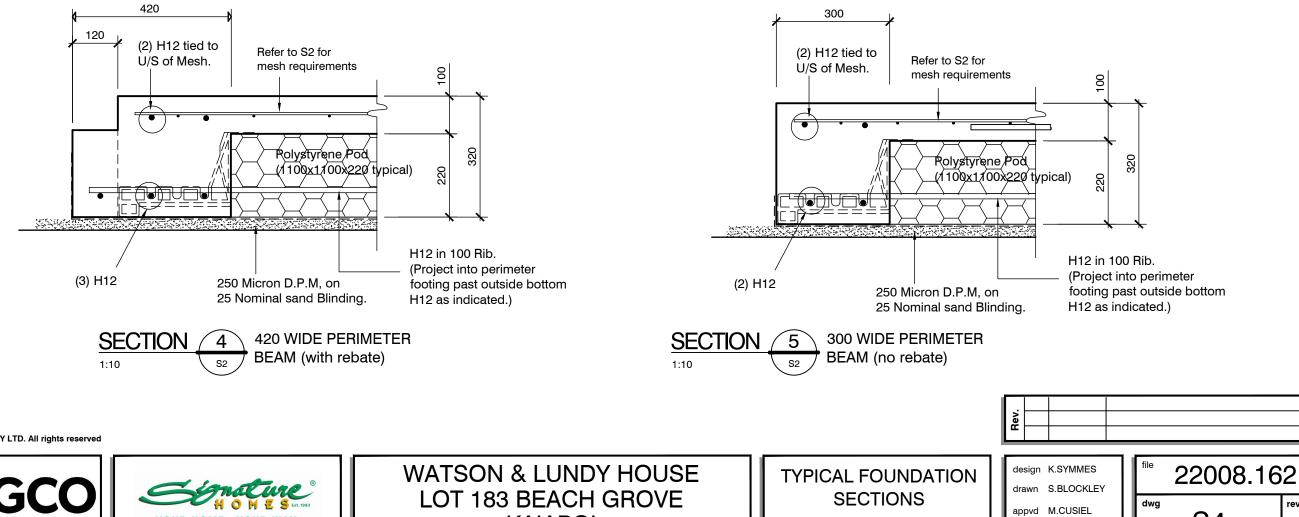

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KAIAPOI


contractor shall verify all dimensions before commencing work BC221027

WAIMAKARIRI DISTRICT COUNCIL Plans and specifications APPROVED in accordance with the Building Act 2004, clause 49 and the Building Regulations 1992, Clause 3 BC221027 15/09/2022 staceyg

ORIGINAL SIZE = A3

rev.



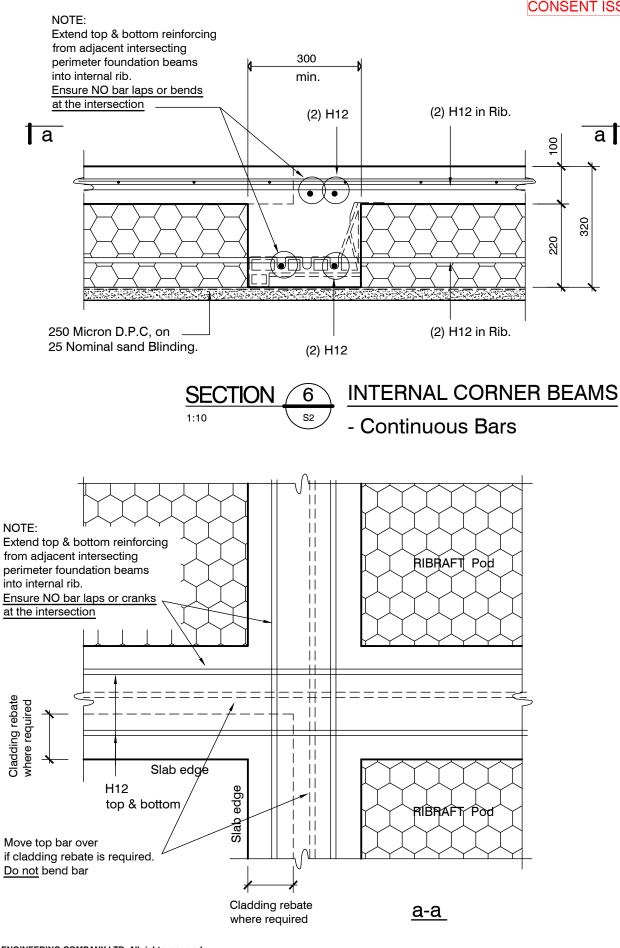

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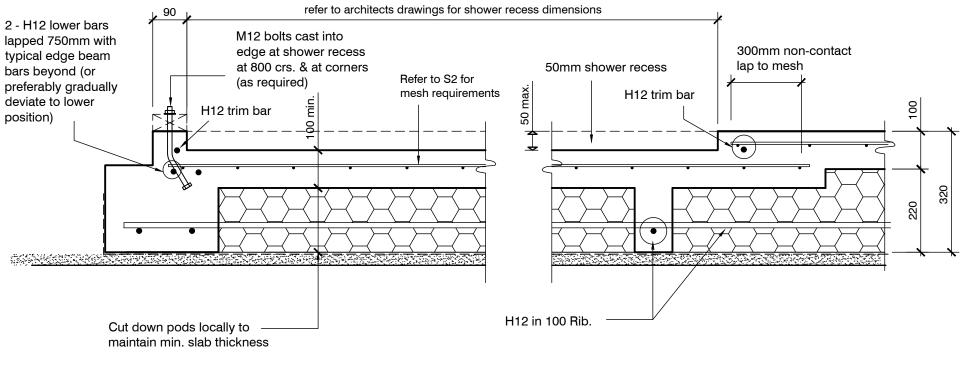
WATSON & LUNDY HOUSE LOT 183 BEACH GROVE KAIAPOI

TYPICAL FOUNDATION SECTIONS ıГ

contractor shall verify all dimensions before commencing work BC221027

> WAIMAKARIRI DISTRICT COUNCIL Plans and specifications APPROVED in accordance with the Building Act 2004, clause 49 and the Building Regulations 1992, Clause 3 BC221027 15/09/2022 staceyg

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TYPICAL SHOWER RECESS - if required (refer to Architects Drawings) 1:10

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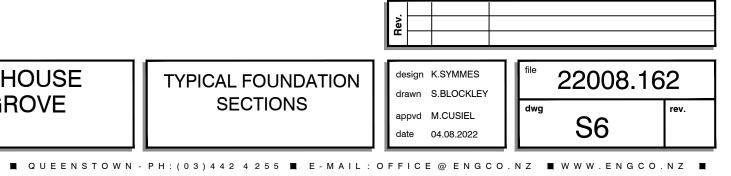




TYPICAL FOUNDATION SECTIONS


contractor shall verify all dimensions before commencing work

WAIMAKARIRI DISTRICT COUNCIL Plans and specifications APPROVED in accordance with the Building Act 2004, clause 49 and the Building Regulations 1992, Clause 3 BC221027 15/09/2022 staceyg



CONSENT ISSUED BC221027 - Page 9 of 31

Pipes can be run in Pods under

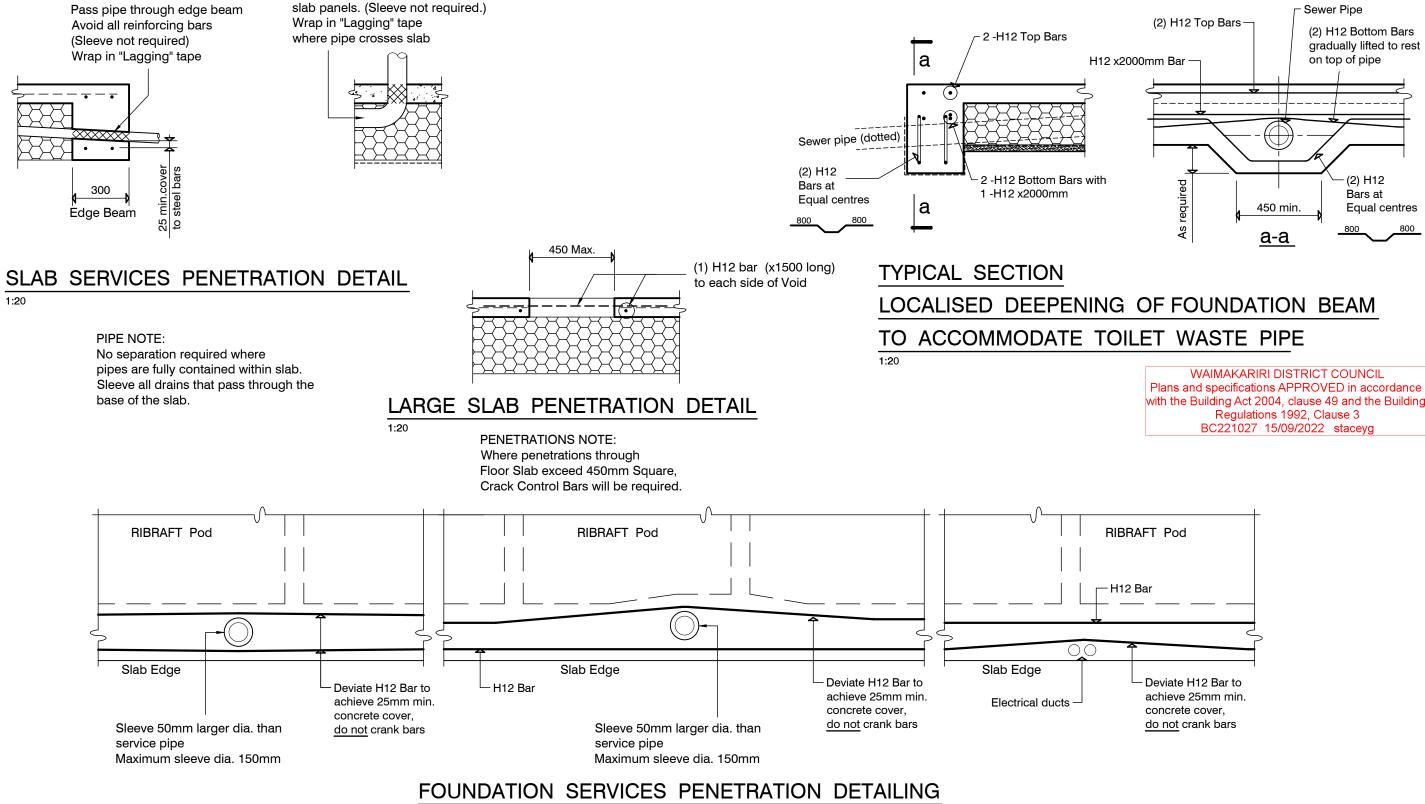

WATSON & LUNDY HOUSE

LOT 183 BEACH GROVE

KAIAPOI

1:20 Services shall not run along ribs or edge beams.

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contractor shall verify all dimensions before commencing work BC221027


with the Building Act 2004, clause 49 and the Building

design K.SYMMES 22008.162 drawn S.BLOCKLEY PENETRATION DETAILS dwg rev. appvd M.CUSIEL **S**7 04.08.2022 date NWW.ENGCO.NZ

TYPICAL SERVICES

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ORIGINAL SIZE

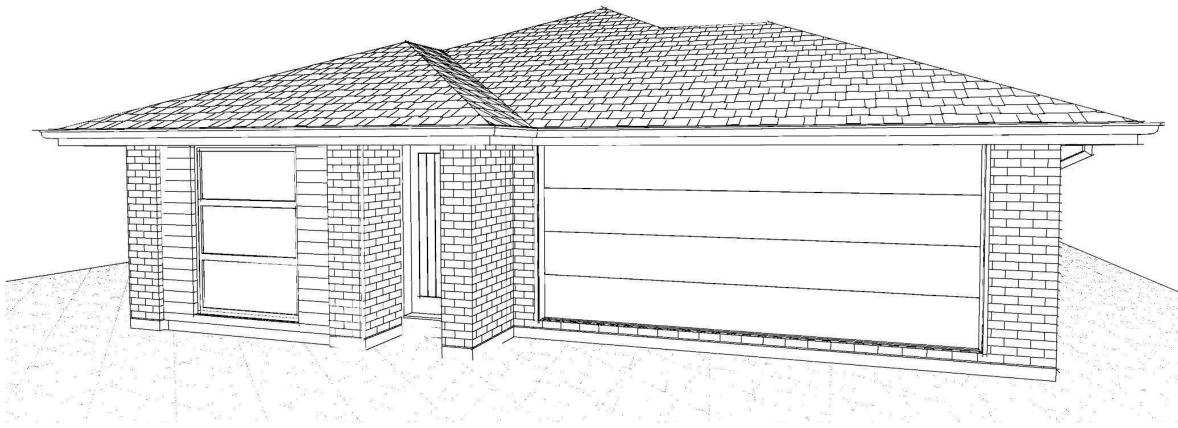

All dimensions are to be check and confirmed prior to any construction Plans are to be read in conjunction with Specifications and all supporting documentation

in o bi is sentence	TKR Homes Ltd. 31 Watts Road, Sockburn PO BOX 11 351 Christchurch 8443	These drawings are limited to and by the extent of the detail covered in the drawings to meet the current New Zealand Building Code (NZBC). Where detail it required for construction and to demonstrate compliance with the current NZBC, a specific request should be made for the required detail to be supplied. No liability will be accepted for any detail or	Jason Watson & Caitlin Lundy Lot 183	Job Numi		Original Plan: Rail		Sheet Name:
YOUR HOME. YOUR WAY.	P: +64 3 342 7788	construction not covered in these drawings and/or carried out by persons other than the designer producing these documents.	Beach Grove, Kaiapoi	Sales: L Caldwell	Drawn: M Glynn	QS: W Xian	Print Date: 16/09/2022	Scale

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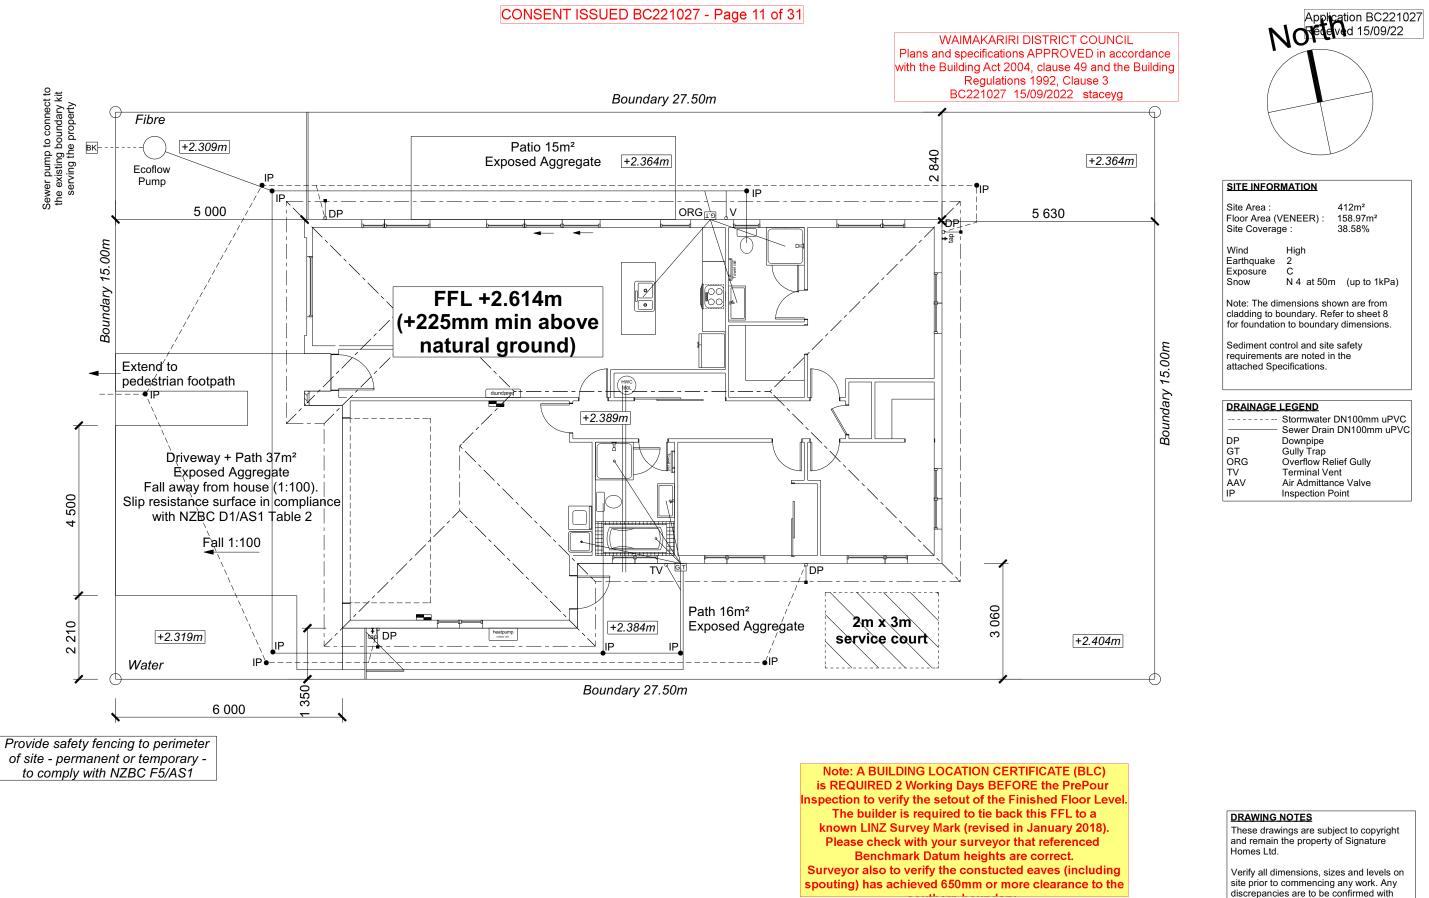
Application BC221027 Received 15/09/22

WAIMAKARIRI DISTRICT COUNCIL Plans and specifications APPROVED in accordance with the Building Act 2004, clause 49 and the Building Regulations 1992, Clause 3 BC221027 15/09/2022 staceyg

Contents:	
Sheet 1 :	Cover Sheet
Sheet 2 :	Site Plan
Sheet 3 :	Floor Plan
Sheet 4 :	Elevations
Sheet 5 :	Elevations
Sheet 6 :	Cross Sections
Sheet 7 :	Roof Plan
Sheet 8 :	Set Out Dimensions
Sheet 9 :	Foundation Plan
Sheet 10 :	Drainage Plan
Sheet 11 :	Bracing Plan
Sheet 12 :	Lighting Plan
Sheet 13 :	Framing Details
Sheet 14 :	Framing Details
Sheet 15 :	Construction Details
Sheet 16 :	Construction Details
Sheet 17 :	Construction Details
Sheet 18 :	Construction Details
Sheet 19 :	Construction Details
Sheet 20 :	Bathroom Details
Sheet 21 :	Truss Design
Sheet 22 :	Truss Design

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CONSENT ISSUED BC221027 - Page 11 of 31





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	TKR Homes Ltd. 31 Watts Road, Sockburn	These drawings are limited to and by the extent of the detail covered in the drawings to meet the current New Zealand	Jason Watson & Caitlin Lundy	Job Num	iber:	Original Plan:	s	heet Name:		С		Sheet No.:
	PO BOX 11 351 Christchurch 8443	Building Code (NZBC). Where detail it required for construction and to demonstrate compliance with the current NZBC, a specific request should be made for the required detail to be supplied. No liability will be accepted for any detail or	Lot 183	1338	59	Rail	SIT	E PLAN	1	No. Date: 1 10-08-2022	Reason: Initial Consent Plans	2
YOUR HOME. YOUR WAY.	P: +64 3 342 7788	construction not covered in these drawings and/or carried out by persons other than the designer producing these documents.	Beach Grove, Kaiapoi	Sales: L Caldwell	Drawn: M Glynn	QS: W Xian	Print Date: 16/09/2022	Scale: 1:100	@ A3			of 22 sheets

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PRICE PLACE

discrepancies are to be confirmed with Signature Homes Ltd.

Refer to attached Specifications for further information

All work is to comply with the NZBC Acceptable Solutions, NZS 3604:2011 and Local Authority bylaws.

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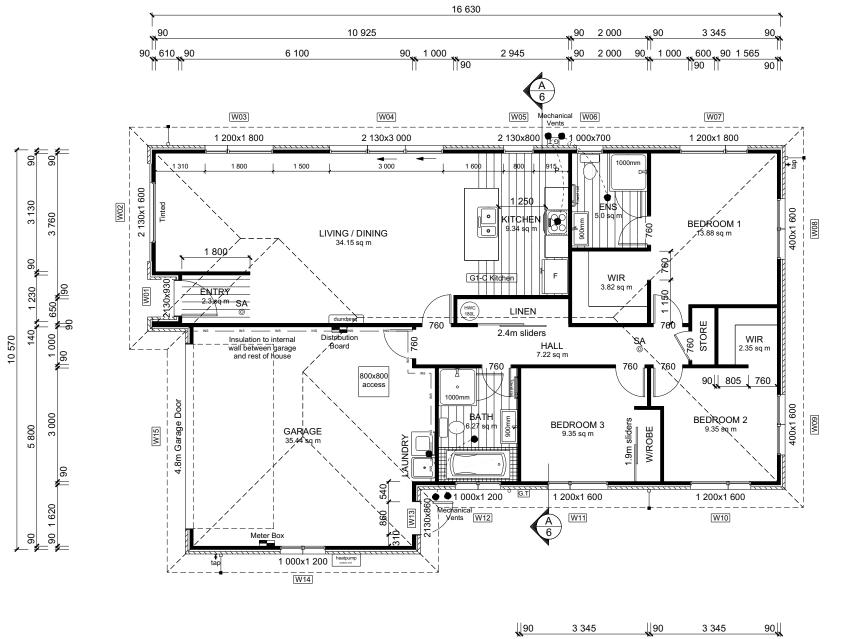
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YOUR HOME. YOUR WAY.	P: +64 3 342 7788	construction not covered in these drawings and/or carried out by persons other than the designer producing these documents.	Beach Grove, Kaiapoi	Sales: L Caldwell	Drawn: M Glynn	QS: W Xian	Print Date: 16/09/2022	Scale: 1:100	@ A3			of 22 sheets

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WAIMAKARIRI DISTRICT COUNCIL Plans and specifications APPROVED in accordance with the Building Act 2004, clause 49 and the Building Regulations 1992, Clause 3 BC221027 15/09/2022 staceyg



ROOF & WALL CLADDINGS

Roof : 25° Pressed Metal Tiles Walls : 70 Series Brick Veneer with a 50mm cavity Herman Pacific Cedar Weatherbaords (HP62) with a 20mm cavity

DWELLING AREAS

Framing Area: 152.53m² (Perimeter: 55.80m) Veneer Area: 158.97m² (Perimeter: 57.00m) Roof Area: 187.47m² (Perimeter: 59.20m)

SMOKE ALARMS (hush type)

Domestic Smoke Alarms to be fitted within 3.0m of sleeping areas and on Escape routes as indicated on plan. To comply with one of the following standards: UL 217, ULC-S531, AS 3786, BS 5446 (part 1).

FLOOR PLAN NOTES

Dimensions shown are to the frame GIB thickness not shown. Mechanical ventilation to comply with G4/AS1 Air Seals to have PEF rod & low expansion foam All windows and doors centered in room unless shown otherwise Laundering facilities provided complying with G2/SA1 1.0 Provide sealant under skirting and paint to concrete around tub & W/M fixtures

WALL FRAMING Stud Height: 2400 mm (2455mm to u/s of bottom chord)

FLOOR FINISHES Carpet & Vinyl

KITCHEN HOB Electric Hobs

DOORS Internal Height: 1980mm (leaves) Type: Hollow core flush panel Front Door Type: Latitude Aluminium

INTERNAL TRIMS Scotia: 55mm GIB Coving (excluding garage) Skirting: 60x12mm Pine, single bevel edge Architrave: N/A

SHELVING Shelf & Rails to all wardrobes 4 shelves to Linen cupboard

DRAWING NOTES

These drawings are subject to copyright and remain the property of Signature Homes Ltd.

Verify all dimensions, sizes and levels on site prior to commencing any work. Any discrepancies are to be confirmed with Signature Homes Ltd.

Refer to attached Specifications for further information

All work is to comply with the NZBC





ELEVATION A

_

BUILDING ENVELOPE RISK MATRIX						
ELEV	ATION B					
RISK CRITERIA	RISK	SCORE				
Wind Zone	High	1				
Number of Stories	Low	0				
Roof Wall Junction	Low	0				
Eaves Width	Medium	1				
Building Envelope	Low	0				
Decks & Balconies	Low	0				
Total		2				

BUILDING ENVELOPE RISK MATRIX

ELEVATION A

RISK

Low

Low

Low

Low

Medium

High

SCORE

0

0

1

0

RISK CRITERIA

Number of Stories

Roof Wall Junction

Eaves Width Building Envelope Decks & Balconies Total

Wind Zone

ELEVATION B

All dimensions are to be check and confirmed prior to any construction Plans are to be read in conjunction with Specifications and all supporting documentation

Genature ii o bi E S En 1983
YOUR HOME. YOUR WAY.

TKR Homes Ltd. 31 Watts Road, Sockburg PO BOX 11 351 Christchurch 8443 P: +64 3 342 7788

ırn	These drawings are limited to and by the extent of the detail covered in the drawings to meet the current New Zealand Building Code (NZBC). Where detail it required for construction and to demonstrate compliance with the current NZBC, a specific request should be made for the required detail to be	Jason
	supplied. No liability will be accepted for any detail or construction not covered in these drawings and/or carried out by persons other than the designer producing these documents.	Be

xtent of the detail t New Zealand ired for construction rrent NZBC, a juired detail to be y detail or	Jason Watson & Caitlin Lundy Lot 183	Job Num 1338		Original Plan: Rail		et Name: ATION	S	Date:	ONSENT PLANS Reason: Initial Consent Plans	Sheet No.:
and/or carried out by these documents.	Beach Grove, Kaiapoi	Sales: L Caldwell	Drawn: M Glynn	QS: W Xian	Print Date: 16/09/2022	Scale: 1:100	@ A3			of 22 sheets

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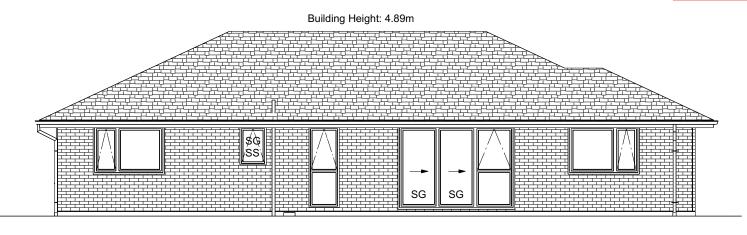
ROOF & WALL CLADDINGS Roof: 25° Pressed Metal Tiles Walls: 70 Series Brick Veneer (Clay) with a 50mm cavity Herman Pacific Cedar Weatherbaords (UPC0)with a 200mm cavity (HP62) with a 20mm cavity

ELEVATION LEGEND SS SG MB TV

ELEVATION NOTES

Gutter : Coloured Steel Quad Gutter Fascia : Coloured Steel185 Fascia Downpipes : Colorsteel Rectangular 75x55mm Soffits : Hardiflex 4.5mm Joinery : Double glazed aluminum

All egress points to have a maximum step down of 190mm. Access routs to have slip resistance surface in compliance with NZBC D1/AS1 Table 2 and to have a 1:100 fall away from the building



ELEVATION C

BUILDING ENVELOPE RISK MATRIX										
ELEVATION D										
RISK CRITERIA	RISK	SCORE								
Wind Zone	High	1								
Number of Stories	Low	0								
Roof Wall Junction	Low	0								
Eaves Width	Medium	1								
Building Envelope	Medium	1								
Decks & Balconies	Low	0								
Total		3								

BUILDING ENVELOPE RISK MATRIX

ELEVATION C

RISK

Low

Low

Low

Low

Medium

High

SCORE

0

0

1

0

RISK CRITERIA

Number of Stories

Roof Wall Junction

Eaves Width Building Envelope Decks & Balconies Total

Wind Zone

ELEVATION D

All dimensions are to be check and confirmed prior to any construction Plans are to be read in conjunction with Specifications and all s

Image: Non-State State	Signature"	TKR Homes Ltd. 31 Watts Road, Sockburn PO BOX 11 351	These drawings are limited to and by the extent of the detail covered in the drawings to meet the current New Zealand Building Code (NZBC). Where detail it required for construction and to demonstrate compliance with the current NZBC, a	Jason Watson & Caitlin Lundy	Job Num 1338		Original Plan: Rail		et Name:	S 1	CONSENT PLANS No. Date: Reason: 10-08-2022 Initial Consent Plans	Sheet No.:
YOUR HOME. YOUR WAY. De attacute 7200 construction not covered in these drawings and/or carried out by construction not covered in these drawings and/or carried out by Beach Grove, Kaiapoi		Christchurch 8443										5
	YOUR HOME. YOUR WAY.			Beach Grove, Kajapoj	Sales:	Drawn:	QS:	Print Date:	Scale:			-
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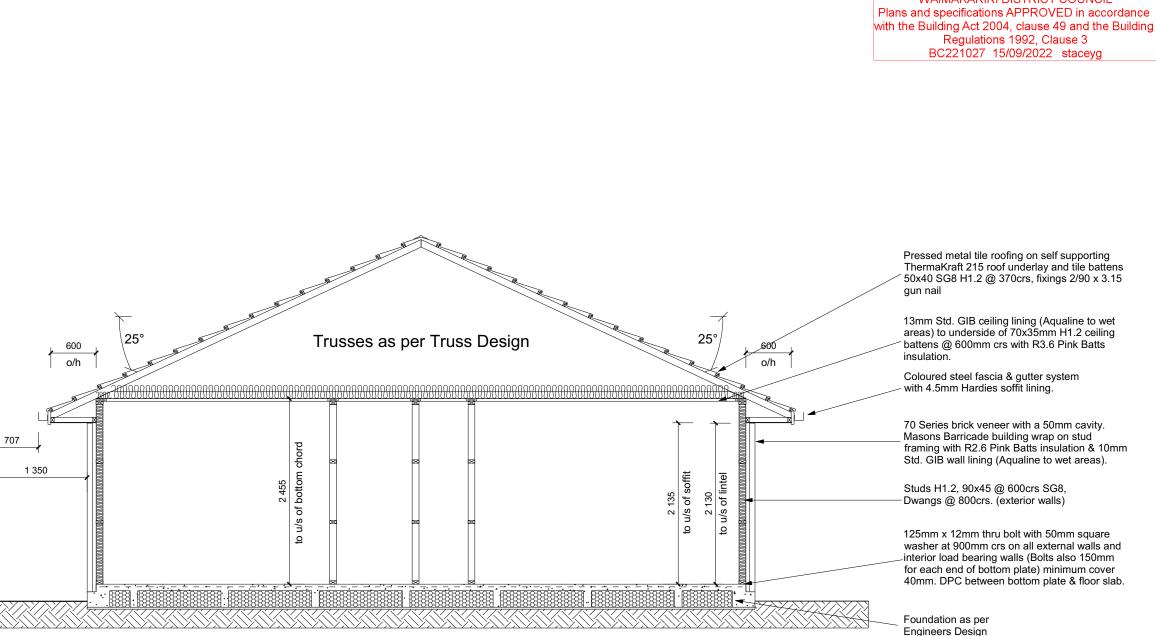
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ELEVATION LEGEND SS SG MB TV

ELEVATION NOTES

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All egress points to have a maximum step down of 190mm. Access routs to have slip resistance surface in compliance with NZBC D1/AS1 Table 2 and to have a 1:100 fall away from the building



CROSS SECTION A-A

All dimensions are to be check and confirmed prior to any construction Plans are to be read in conjunction with Specifications and all supporting docur

Boundary Line

Anature	TKR Homes Ltd. 31 Watts Road, Sockburn PO BOX 11 351	These drawings are limited to and by the extent of the detail covered in the drawings to meet the current New Zealand Building Code (NZBC). Where detail it required for construction and to demonstrate compliance with the current NZBC, a specific request should be made for the required detail to be	Jason Watson & Caitlin Lundy	Job Num 1338		Original Plan: Rail		et Name: SECTIONS	No. Date: 1 10-08-2022	Reason: Initial Consent Plans	Sheet No.:
YOUR HOME. YOUR WAY.	Christchurch 8443 P: +64 3 342 7788	supplied. No liability will be accepted for any detail or construction not covered in these drawings and/or carried out by persons other than the designer producing these documents.	Lot 183 Beach Grove, Kaiapoi	Sales: L Caldwell	Drawn: M Glynn	QS: W Xian	Print Date: 16/09/2022	Scale: 1:50 @ A3			of 22 sheets

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Application BC221027
Received 15/09/22

WAIMAKARIRI DISTRICT COUNCIL

ROOF & WALL CLADDINGS

Roof: 25° Pressed Metal Tiles Walls: 70 Series Brick Veneer with a 50mm cavity Herman Pacific Cedar Weatherbaords (HP62) with a 20mm cavity

CROSS SECTION NOTES

Building wrap is to comply with E2/AS1 & NZS 3604:2011. Flashing materials must be selected based on environmental exposure. Refer to NZS 3604:2011 & table 20 of E2/AS1. Flashing tape must have proven compatibility with the selected wrap & other materials with

which it comes into contract as per table 21 of E2/AS1.

Fixings shall comply with NZS 3604:2011 Section 4 Durability Tables 4.1-4.3 Unless stated otherwise, timber members on drawings are to be a minimum of SG8 strength graded as per NZS3604:2011.

INSULATION Ceiling: Pink Batts R3.6 Ceiling Batts Wall: Pink Batts R 2.6 Wall Batts


DRAWING NOTES

These drawings are subject to copyright and remain the property of Signature Homes Ltd.

Verify all dimensions, sizes and levels on site prior to commencing any work. Any discrepancies are to be confirmed with Signature Homes Ltd.

Refer to attached Specifications for further information

All work is to comply with the NZBC Acceptable Solutions, NZS 3604:2011 and Local Authority bylaws.

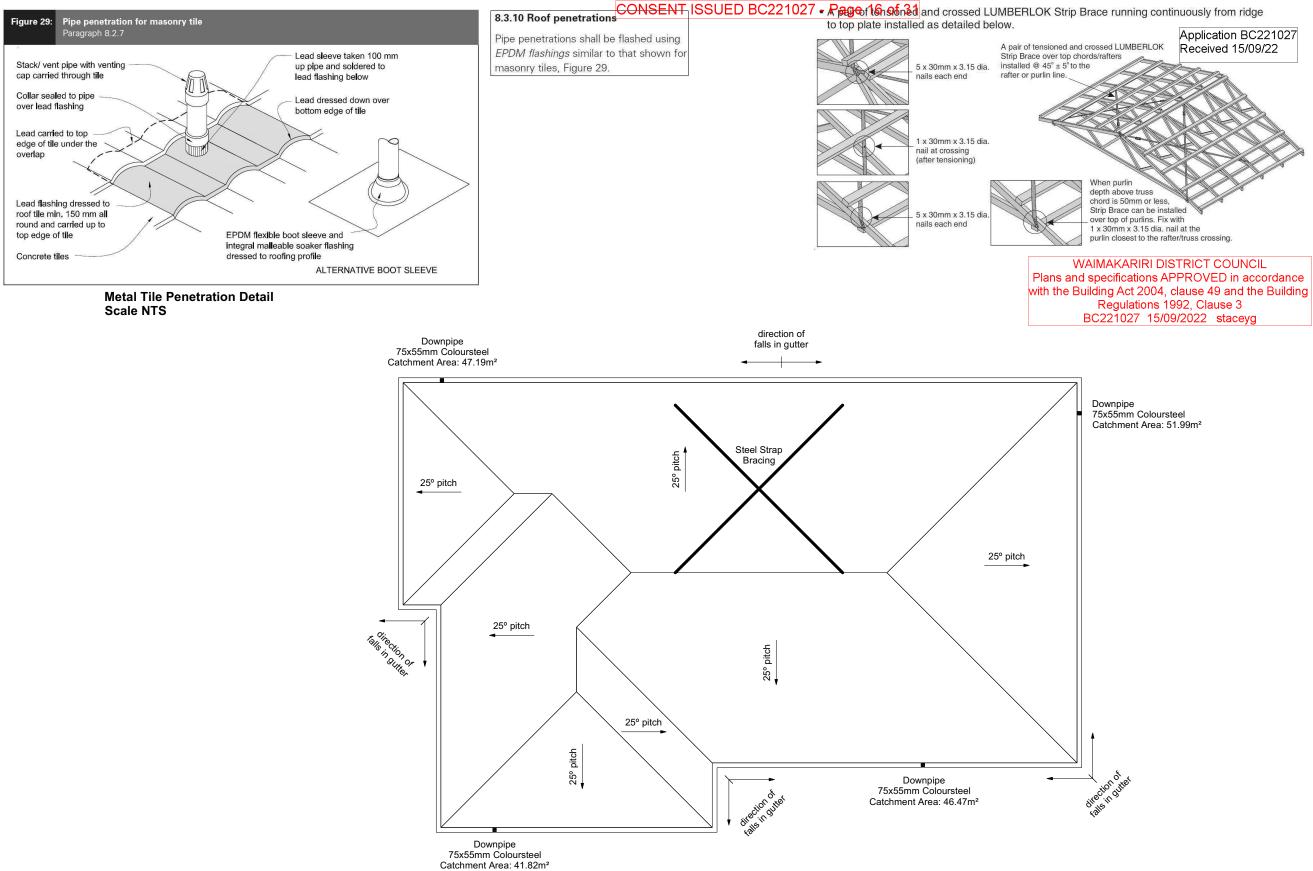

All dimensions are to be check and confirmed prior to any construction Plans are to be read in conjunction with Specifications and all supporting documentation

it O by it S En 195	31 Watts Road, Sockburn	These drawings are limited to and by the extent of the detail covered in the drawings to meet the current New Zealand Building Code (NZBC). Where detail it required for construction and to demonstrate compliance with the current NZBC, a specific request should be made for the required detail to be	Jason Watson & Caitlin Lundy Lot 183	Job Number: 133859	Original Plan: Rail		neet Name: DF PLAN	No. Date: R 1 10-08-2022 Ir	Reason: iitial Consent Plans	Sheet No.:
YOUR HOME. YOUR WAY.	P: +64 3 342 7788	supplied. No liability will be accepted for any detail or construction not covered in these drawings and/or carried out by persons other than the designer producing these documents.	Beach Grove, Kaiapoi	Sales: Drawn L Caldwell M Gly		Print Date: 16/09/2022	Scale: 1:100 @ A3			of 22 sheets

ROOF CLADDING

Roofing : 25° Pressed Metal Tiles Tile Battens : 50x40 SG8 H1.2 @ 370crs, fixings 2/90 x 3.15 gun nail

ROOF PLAN NOTES


Gutter: Coloured Steel Quad Gutter Fascia: Coloured Steel 185 Fascia Downpipes: Colorsteel Rectangular 75x55mm Soffits: Hardiflex 4.5mm

Underlay: Thermakraft 215 roof underlay

Downpipes: 75x55 Rectangle Colorsteel As per NZBC E1/AS1 Table 5 75x55 down pipes can collect up to 60m² of 0-25° roof plan area.

Use Coloured steel Quad Gutter As per NZ Metal Roof and Wall Cladding Code of Practice Version 2 section 8 the above gutter with a cross sectional area of 5550mm^2 can collect up to 60m^2 of 0-25° roof plan area. Refer to the specifications for exact calculations

Use Lumberlock top plate fixing chart attached to the main specifications to determine top plate fixings.

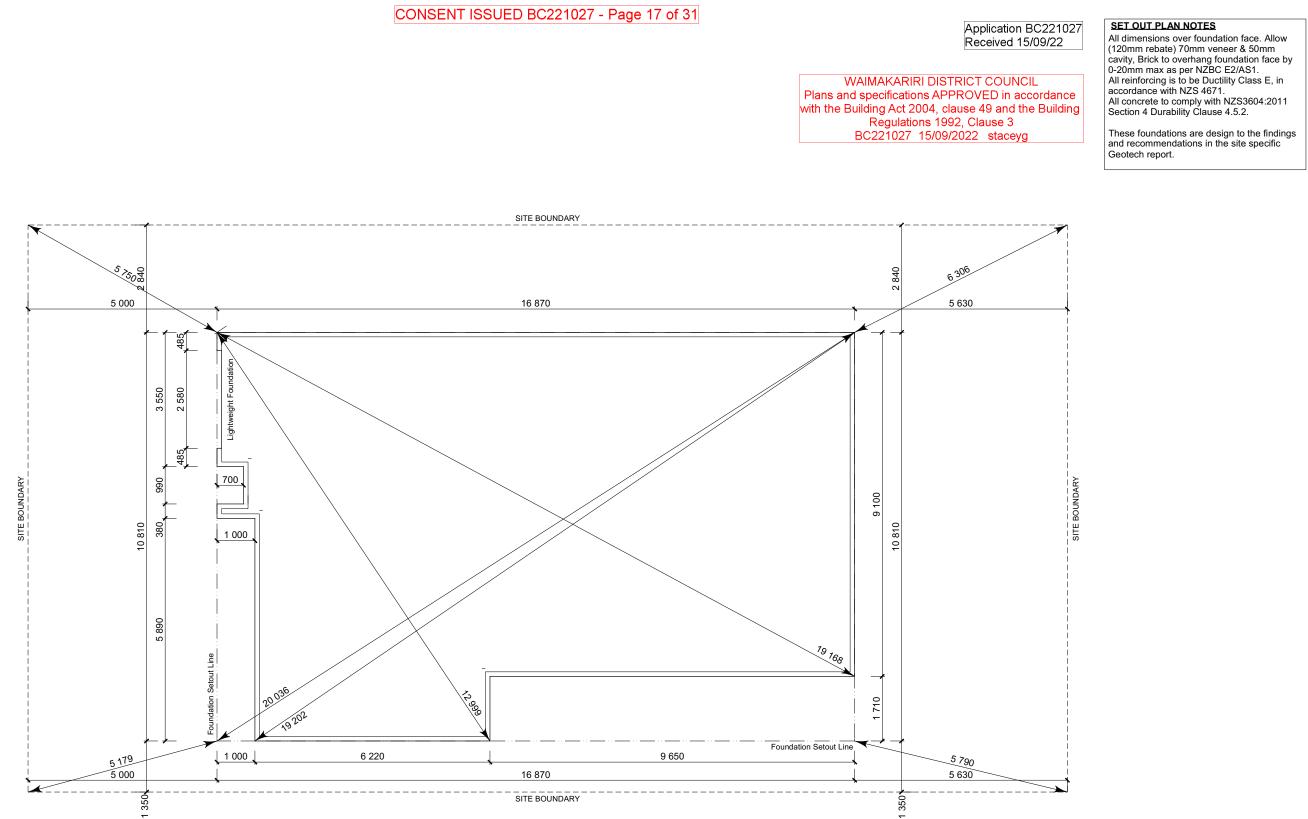


PROPOSED ROAD

All dimensions are to be check and confirmed prior to any construction Plans are to be read in conjunction with Specifications and all supporting docum

in o by it is second	31 Watts Road, Sockburn	These drawings are limited to and by the extent of the detail covered in the drawings to meet the current New Zealand Building Code (NZBC). Where detail it required for construction and to demonstrate compliance with the current NZBC, a specific request should be made for the required detail to be	Jason Watson & Caitlin Lundy Lot 183	Job Num 1338		Original Plan: Rail		et Name: DIMENSIONS	Date: Reason: 10-08-2022 Initial Consent Plans	Sheet No.: 8
YOUR HOME. YOUR WAY.		supplied. No liability will be accepted for any detail or construction not covered in these drawings and/or carried out by persons other than the designer producing these documents.	Beach Grove, Kaiapoi	Sales: L Caldwell	Drawn: M Glynn	QS: W Xian	Print Date: 16/09/2022	Scale: 1:100 @ A3		of 22 sheets

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Plans and specifications APPROVED in accordance with the Building Act 2004, clause 49 and the Building Regulations 1992, Clause 3 BC221027 15/09/2022 staceyg

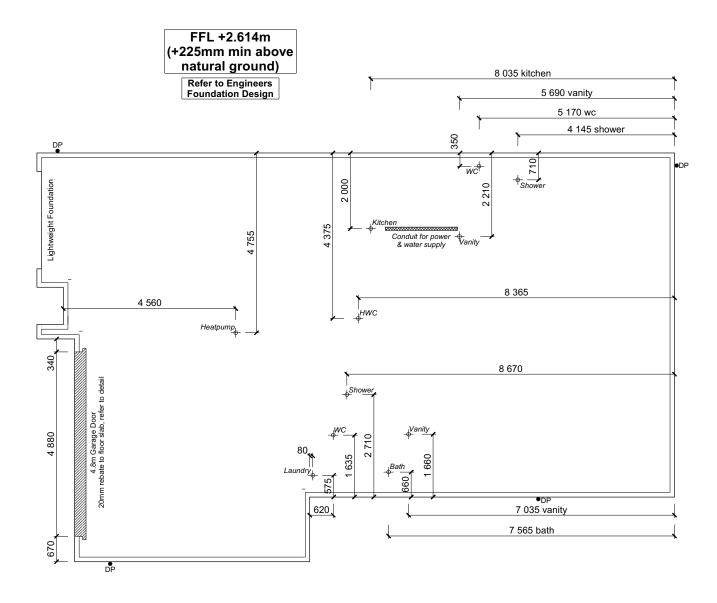

All dimensions are to be check and confirmed prior to any construction Plans are to be read in conjunction with Specifications and all supporting documentation

in O by it S EN 1983	TKR Homes Ltd. 31 Watts Road, Sockburn PO BOX 11 351 Christchurch 8443	These drawings are limited to and by the extent of the detail covered in the drawings to meet the current New Zealand Building Code (NZBC). Where detail it required for construction and to demonstrate compliance with the current NZBC, a specific request should be made for the required detail to be	Jason Watson & Caitlin Lundy Lot 183	Job Nur 1338		Original Plan: Rail	Sheet Name: FOUNDATION PLA	No Data:	Reason: Initial Consent Plans	Sheet No.: 9
YOUR HOME. YOUR WAY.	P: +64 3 342 7788	supplied. No liability will be accepted for any detail or construction not covered in these drawings and/or carried out by persons other than the designer producing these documents.	Beach Grove, Kaiapoi	Sales: L Caldwell	Drawn: M Glynn	QS: W Xian	Print Date: Scale: 16/09/2022 1:100 @ A	3		of 22 sheets

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Application BC221027 Received 15/09/22

WAIMAKARIRI DISTRICT COUNCIL


FOUNDATION PLAN NOTES

All dimensions over foundation face. Allow (120mm rebate) 70mm veneer & 50mm cavity, Brick to overhang foundation face by 0-20mm max as per NZBC E2/AS1. W/C location indicated on plan has assumed a 140mm offset from internal frame line, please consult manufacturer's documentation to confirm offset. Contractor to consult manufacturer's documentation to determine the correct location for all wastes positioned through floor slabs. Earth bar to be bonded to the reinforcing mesh Refer to Truss design for exact location of slab thickenings

All reinforcing is to be Ductility Class E, in accordance with NZS 4671. All concrete to comply with NZS3604:2011 Section 4 Durability Clause 4.5.2.

These foundations are design to the findings and recommendations in the site specific Geotech report.

CONSENT ISSUED BC221027 - Page 19 of 31 WAIMAKARIRI DISTRICT COUNCIL Plans and specifications APPROVED in accordance with the Building Act 2004, clause 49 and the Building Regulations 1992, Clause 3 BC221027 15/09/2022 staceyg

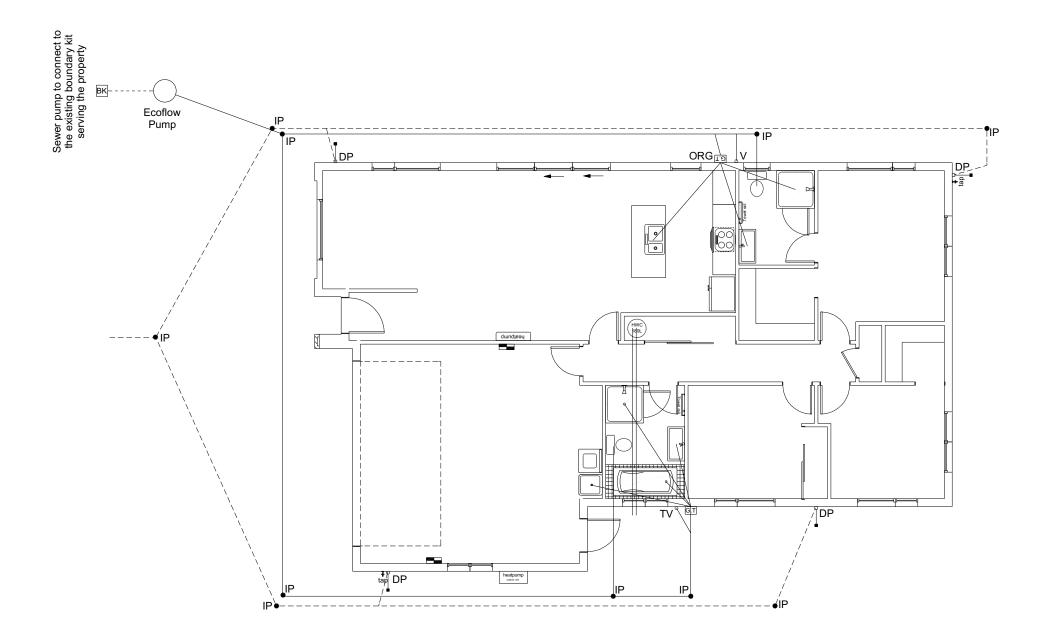

All dimensions are to be check and confirmed prior to any construction Plans are to be read in conjunction with Specifications and all s

Cignat Ture	31 Watts Road, Sockburn	These drawings are limited to and by the extent of the detail covered in the drawings to meet the current New Zealand Building Code (NZBC). Where detail it required for construction and to demonstrate compliance with the current NZBC, a	Jason Watson & Caitlin Lundy	Job Num 1338		Original Plan: Rail	Sheet Name:		Date: Reason: 10-08-2022 Initial Consent Plans	Sheet No.:
HOMES Est. 1983	Christchurch 8443	specific request should be made for the required detail to be supplied. No liability will be accepted for any detail or	Lot 183	1330	53					10
YOUR HOME. YOUR WAY.	P: +64 3 342 7788	construction not covered in these drawings and/or carried out by persons other than the designer producing these documents.	Beach Grove, Kaiapoi	Sales: L Caldwell	Drawn: M Glynn	QS: W Xian	Print Date: Scale: 16/09/2022 1:100	@ \$3		of 22 sheets
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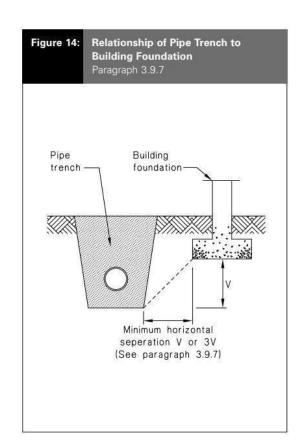
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Plumbing Schedule	NZBC G13		
Kitchen Sink:	Ø50mm @1:40	(3 di	scharge units)
Bathrooms		(0 0.	
Vanity:	Ø40mm @ 1:40		scharge units per basin)
Shower:	Ø40mm @1:40	(2 di	scharge units)
Bath:	Ø40mm @1:40		scharge units)
WC:	Ø100mm @1:40	(4 di	scharge units)
Laundry Sink:	Ø40mm @1:30	(5 di	scharge units)
Drainage Schedule	NZBC G13		
Main Foulwater			Application BC221027
Vented Drain	Ø100mm @1:60		
Stormwater Drain	Ø100mm @1:60 (1:12	0min)	Received 15/09/22
Terminal Vent	Ø80mm		
Vent	Ø50mm		
Heatpump	Drain over GT		
ORG	Overflow Relief Gully		
Notes:			
	hage to comply with NZBC	G13	
	so the top of gully dish is		than 150mm below
	se the top of gaily alon lo		


overflow level of lowest fixture

Sewer & Stormwater to connect to existing connections. All drains passing through concrete, provide sleeve or wrap in durable and flexible to allow for expansion and contraction. (as per G13/AS2 5.8.1) HWC: Safe tray to HWC with 50mm overflow drain to exterior to comply with G12/AS1.

DRAINAG	LEGEND
	 Stormwater DN100mm uPVC
	 Sewer Drain DN100mm uPVC
DP	Downpipe
GT	Gully Trap
ORG	Overflow Relief Gully
TV	Terminal Vent
AAV	Air Admittance Valve
IP	Inspection Point






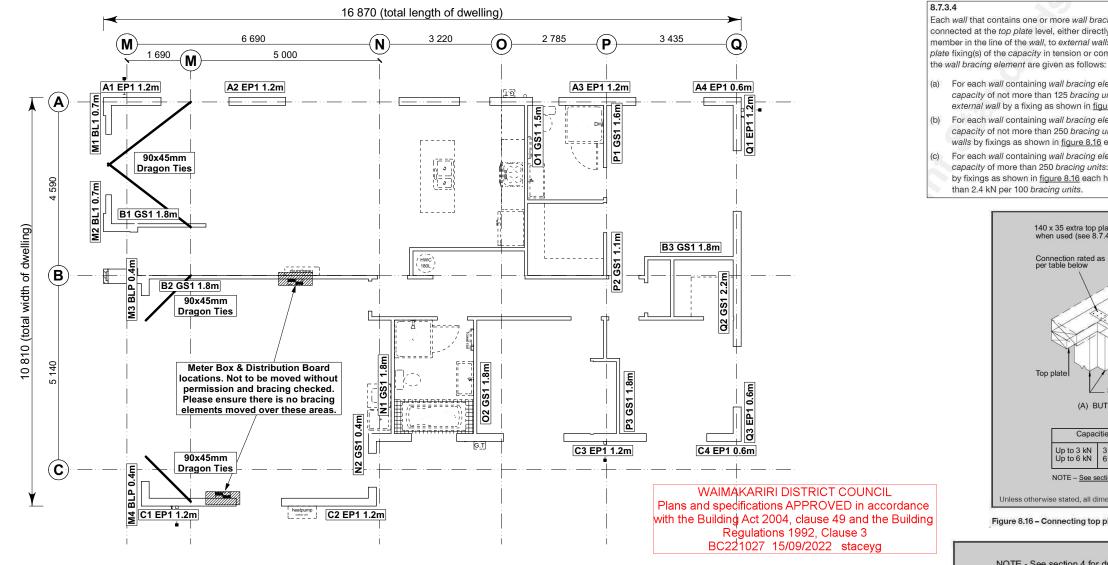

Job N	ame: Watso	on & Lund	У						Wind	EQ
									Der	nand
									566	955
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Line	Element	Length	Angle	Stud Ht.	Туре	Supplier	Wind	EQ	1351	1422
		(m)	(degrees)	(m)			(BUs)	(BUs)	239%	149%
	1	1.20		2.4	EP1 1.2	Ecoply®	144	162		
	2	1.20		2.4	EP1 1.2	Ecoply®	144	162		
А	3	1.20		2.4	EP1 1.2	Ecoply®	144	162		
4	0.60		2.4	EP1 0.6	Ecoply®	57	63			
									489 OK	549 OK
	1	1.80		2.4	GS1-N	GIB®	124	108		
в	2	1.80		2.4	GS1-N	GIB®	124	108		
D	3	1.80		2.4	GS1-N	GIB®	124	108		
					-				373 OK	324 OK
	1	1.20		2.4	EP1 1.2	Ecoply®	144	162		
	2	1.20		2.4	EP1 1.2	Ecoply®	144	162		
С	3	1.20		2.4	EP1 1.2	Ecoply®	144	162		
	4	0.60		2.4	EP1 0.6	Ecoply®	57	63		
									489 OK	549 OK

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$ \begin{tabular}{ c c c c c c c c c c } \hline & & & & & & & & & & & & & & & & & & $			(m)	(degrees)	(m)			(BUs)	(BUs)	143%	126%
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Unless otherwise stated, all dimensions are in mm.

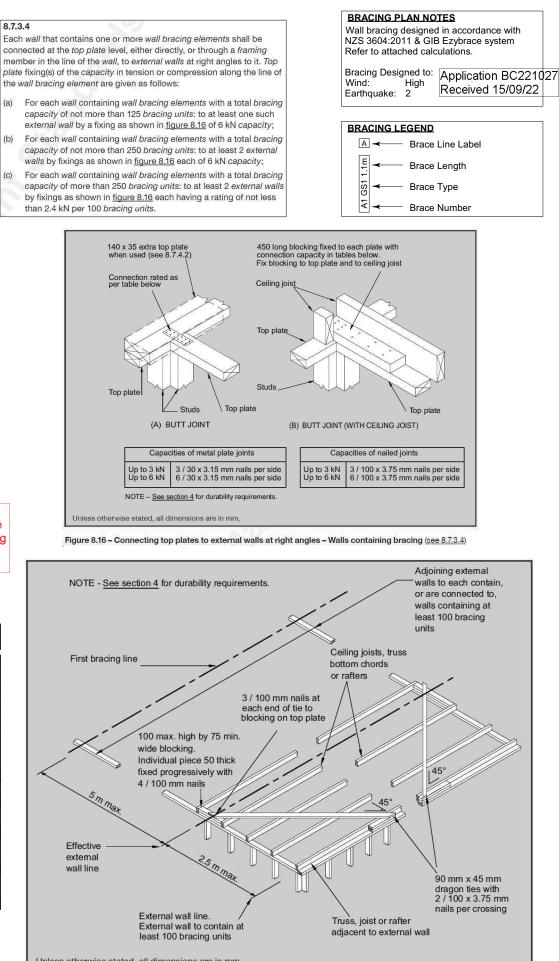Print Date

16/09/2022

All dimensions are to be check and confirmed prior to any construction Plans are to be read in conjunction with Specifications and all supporting docu




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Jason Watson & Caitlin Lundy	Job Nun	nber:	Original Plan:
Lot 183	1338	59	Rail
Beach Grove, Kaiapoi	Sales:	Drawn:	QS:
	L Caldwell	M Glynn	W Xian

Sheet	Name:			C	ONSENT PLANS	Sheet No.:
BRACIN	IG PLAN		No. 1	Date: 10-08-2022	Reason: Initial Consent Plans	11
nt Date: 09/2022	Scale: 1:100 @	A3				of 22 sheets



All dimensions are to be check and confirmed prior to any construction Plans are to be read in conjunction with Specifications and all supporting documentation

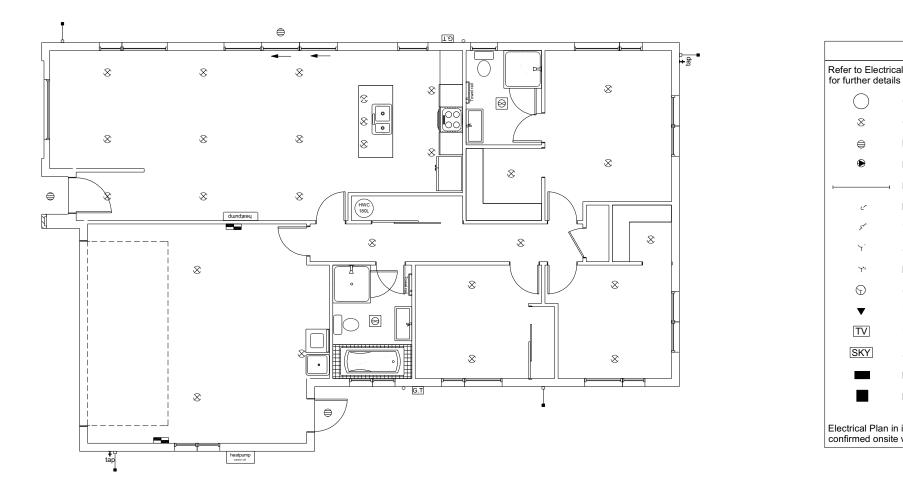HICH IS SENTING		Lot 183	13385	59	Rail		NG PLAN	1 10-08	-2022 Initial Consent Plans	∃ 12
YOUR HOME. YOUR WAY. P: +64 3 342 7	supplied. No liability will be accepted for any detail or construction not covered in these drawings and/or carried out by		Sales: L Caldwell	Drawn: M Glynn	QS: W Xian	Print Date: 16/09/2022	Scale: 1:100 @ A3			of 22 sheets

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Application BC221027 Received 15/09/22

WAIMAKARIRI DISTRICT COUNCIL Plans and specifications APPROVED in accordance with the Building Act 2004, clause 49 and the Building Regulations 1992, Clause 3 BC221027 15/09/2022 staceyg

LEGEND

Refer to Electrical Section in Specification

Ceiling Pan

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TV

SKY

- CA Approved Down Light
- Exterior Bulkhead Light
- Exterior Wall Light
- Fluorescent Double
- Light Switch
- Two Way Light Switch
- Single Power Socket
- Double Power Socket
- Outside Waterproof Plug
- Telephone/Data Outlet
- TV Jack
- Sky Connection
- Bathroom Heater
- Bathroom Extractor/Light


Electrical Plan in indicative only and is to be confirmed onsite with electrician and client

CONSENT ISSUED BC221027 - Page 22 of 31 01/2017

IUMBERLOK® LINTEL FIXING SCHEDULE **ALTERNATIVE TO TABLE 8.14 & FIGURE 8.12** NZS 3604:2011

NOTE:

- ★ All fixings are designed for vertical loads only. Dead loads include the roof weight and standard ceiling weight of 0.20kPa.
- ★ Refer to Table 8.19 NZS 3604:2011 for nailing schedule to resist horizontal loads.
- ★ These fixings assume the correct choice of rafter/truss to top plate connections have been made
- * All fixings assume bottom plate thickness of 45mm maximum. Note: TYLOK options on timber species.
- * Wall framing arrangements under girder trusses are not covered in this schedule.
- ★ All timber selections are as per NZS 3604:2011.

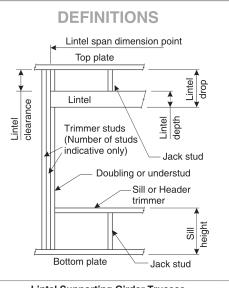

Li	ntel Sup	porting	Girder 1	russes				
Roof Tributary	L	ight Roo	of	Heavy Roof				
Area	V	/ind Zon	е	Wind Zone				
	L, M, H	VH	EH	L, M, H	VH	EH		
8.6m ²	G	G	н	G	G	н		
11.6m ²	G	Н	Н	G	G	Н		
12.1m ²	G	Н	Н	G	Н	Н		
15.3m ²	Н	Н	-	G	Н	Н		
19.1m ²	Н	-	-	G	Н	-		
20.9m ²	Н	-	-	Н	Н	-		
21.8m ²	Н	-	-	Н	-	-		
34.3m ²	-	-	-	Н	-	-		

NOTES:

- 1. Roof Tributary Area = approx. $1/2 \times (Total roof area on girder and rafter)$ trusses supported by lintel)
- 2. Assumed girder truss is at mid-span or middle third span of lintel
- 3. Use similar fixings for both ends of lintel
- 4. All other cases require specific engineering design

All dimensions are to be check and confirmed prior to any construction
Plans are to be read in conjunction with Specifications and all supporting documentation

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These drawings are lim covered in the drawings

Building Code (NZBC)


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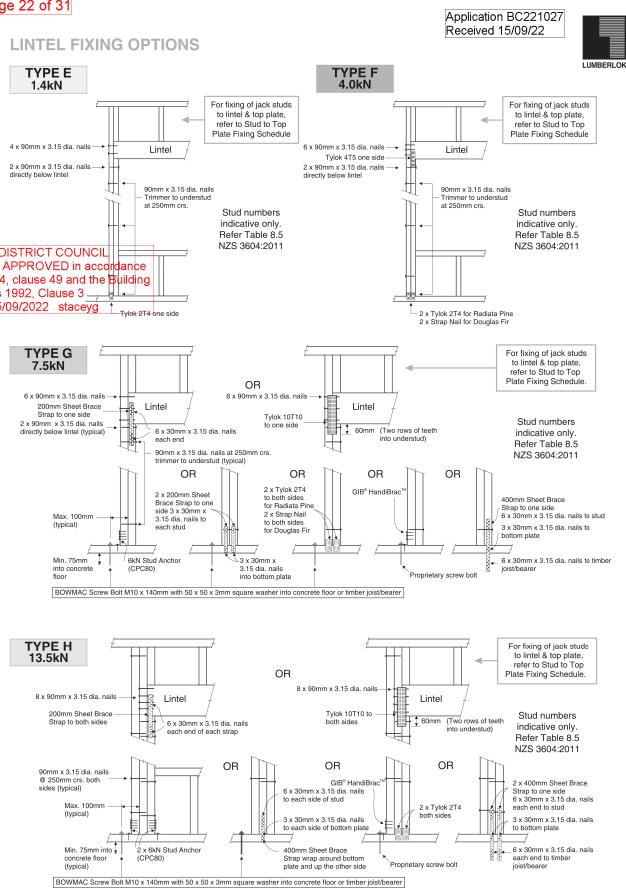
specific request should

supplied. No liability wil construction not covere

persons other than the

Lintel	Loaded			ht R					avy F nd Zo		
Span (m)	Dimension (m) (See Fig. 1.3 NZS 3604:2011)	L	м	н	νн	EH	L	М	н	VH	EH
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	3.0	E	E	F	F	F	E	E	E	F	F
1.0	4.0	E	F	F	F	G	E	E	F	F	F
1.0	5.0	E	F	F	G	G	E	E	F	F	G
		E	F	F		G	E	E	F	F	
	6.0		-		G						G
	2.0	Е	E	F	F	F	E	E	E	F	F
	3.0	Е	E	F	F	F	E	E	F	F	F
1.2	4.0	Е	F	F	G	G	Е	Е	F	F	G
	5.0	Е	F	F	G	G	Е	Е	F	F	G
	6.0	F	F	G	G	Н	Е	Е	F	G	G
	2.0	Е	Е	F	F	F	Е	Е	E	F	F
	3.0	Е	F	F	F	G	Е	Е	F	F	F
1.5	4.0	E	F	F	G	G	E	E	F	F	G
1.0	5.0	F	F	G	G	H	E	E	F	G	G
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- .0	4.0	F	G	Н	-	-	Е	F	Н	Н	-
	5.0	G	Н	-	-	-	Е	F	Н	-	-
	6.0	G	Н	-	-	-	Е	F	Н	-	-
	2.0	F	F	G	Н	Н	Е	F	G	G	Н
	3.0	F	G	H	H	-	E	F	G	H	H
	3.5	F	G	H	-	-	E	F	G	H	-
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		G	H		-		E	F	H		-
	5.0			-		-				-	
	6.0	G	H	-	-	-	E	G	Н	-	-
	2.0	F	F	G	H	Н	E	F	G	G	H
	2.8	F	G	H	Н	-	E	F	G	H	Н
5.4	3.0	F	G	Н	-	-	E	F	G	Н	-
0.4	4.0	G	Н	Н	-	-	E	F	Н	-	-
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limited to and by the extent of the detail ngs to meet the current New Zealand	Jason Watson & Caitlin Lundy	Job Number: 133859		Original Plan:	Sheet Name:			CC	DNSENT PLANS	Sheet No.:
C). Where detail it required for construction compliance with the current NZBC, a uld be made for the required detail to be will be accepted for any detail or ered in these drawings and/or carried out by ne designer producing these documents.	Lot 183 Beach Grove, Kaiapoi			Rail	FRAMING DETAILS		No. 1		Reason: Initial Consent Plans	13
		Sales: L Caldwell	Drawn: M Glynn	QS: W Xian	Print Date: 16/09/2022	Scale: NTS @ A3				of 22 sheets

CONSENT ISSUED BC221027 - Page 23 of 31 08/2017 **IUMBERLOK**[®]

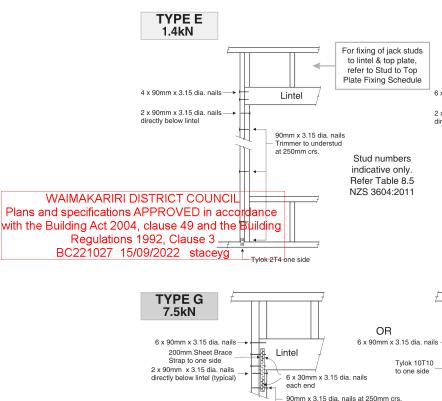STUD TO TOP PLATE FIXING SCHEDULE ALTERNATIVE TO TABLE 8.18 NZS 3604:2011

NOTE:


- ★ All fixings are designed to resist vertical loads only. Dead loads include the roof weight and standard ceiling weight of 0.20kPa.
- ★ Refer to Table 8.19 NZS 3604:2011 for nailing schedule to resist lateral loads.
- ★ These fixings assume the correct choice of rafter/truss to top plate connections have been made.
- ★ For gable end walls where the adjacent rafter/truss is located within 1200mm and with a maximum verge overhang of 750mm, select stud to top plate fixing using a loaded dimension of 1.5m.
- ★ All fixings assume top plate thickness of 45mm maximum.

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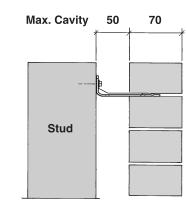
- * Wall framing arrangements under girder trusses are not covered in this schedule.
- ★ All timber selections are as per NZS 3604:2011.

LOADED DIMENSION DEFINITION

FIXING OPTIONS

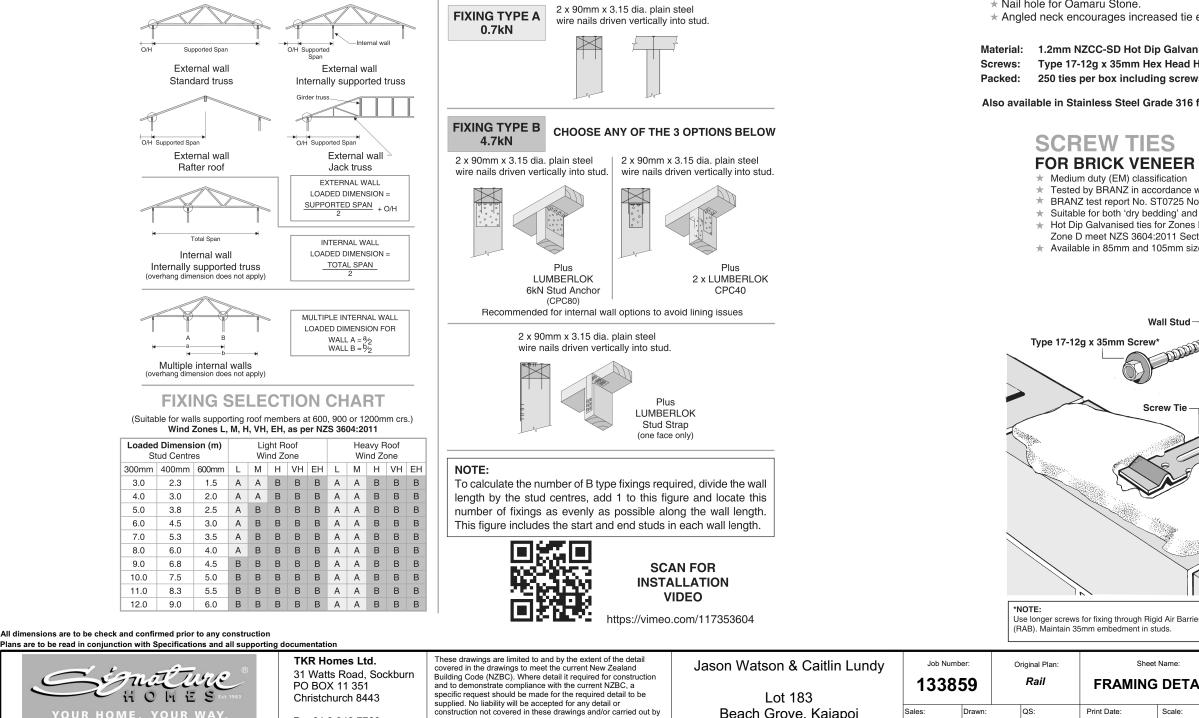

persons other than the designer producing these documents



70 SERIES BRICK

Screw Tie Short (85mm)

- are not to be hammered into timber framing.
- * Nail hole for Oamaru Stone.
- * Angled neck encourages increased tie embedment in mortar.

Material:	1.2mm NZCC-SD Hot Dip 0
Screws:	Type 17-12g x 35mm Hex H
Packed:	250 ties per box including

SCREW TIES FOR BRICK VENEER FIXING

- ★ Medium duty (EM) classification
- * BRANZ test report No. ST0725 November 2007
- Zone D meet NZS 3604:2011 Sect. 4 Durability
- ★ Available in 85mm and 105mm sizes

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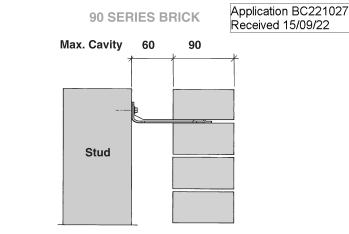
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Beach Grove, Kaiapoi


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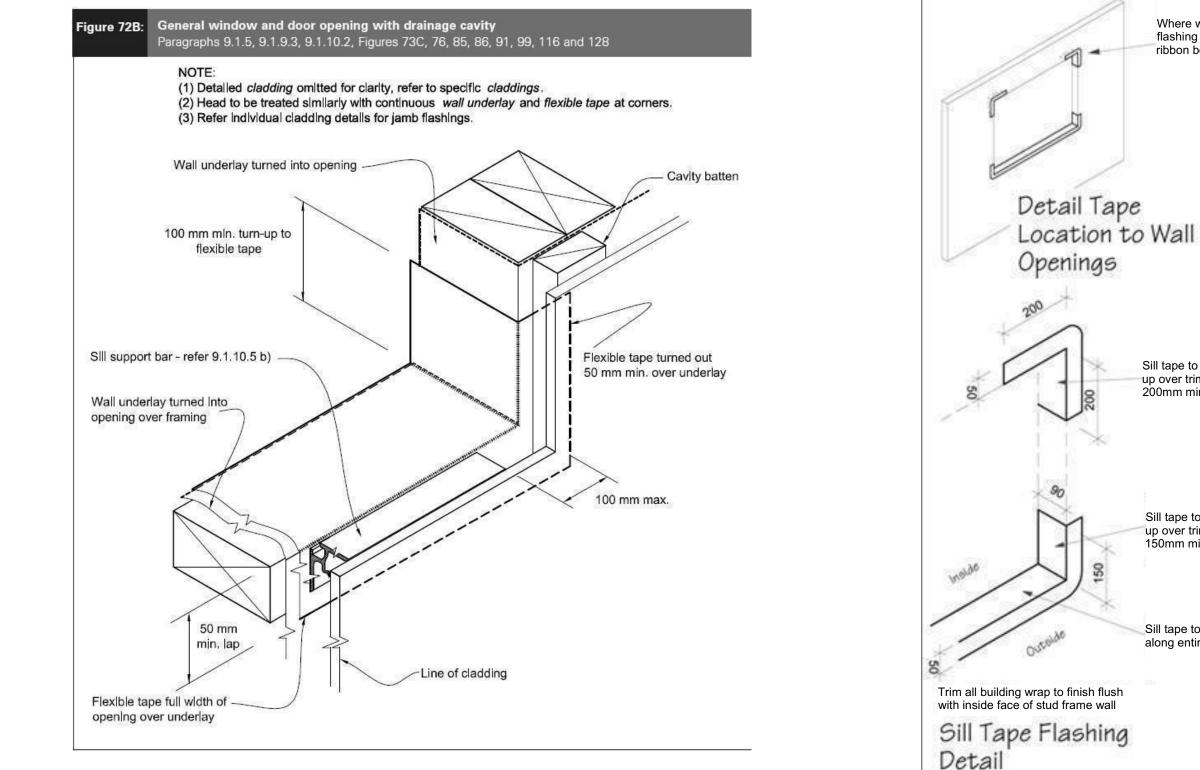
Screw Tie Long (105mm)

★ All brick work must be constructed in accordance with NZS 4210:2001 Masonry Construction:Materials and Workmanship. Screw Ties must be applied accordingly and

* Water shedding shoulder prevents transfer of the moisture from tie to building.



of 22 sheets

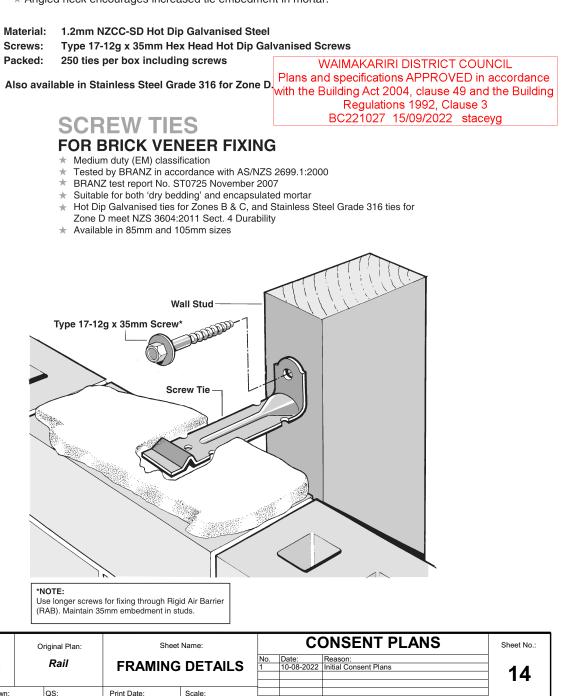

All dimensions are to be check and confirmed prior to any construction Plans are to be read in conjunction with Specifications and all

HOMES TANK	TKR Homes Ltd. 31 Watts Road, Sockburn PO BOX 11 351 Christchurch 8443	These drawings are limited to and by the extent of the detail covered in the drawings to meet the current New Zealand Building Code (NZBC). Where detail it required for construction and to demonstrate compliance with the current NZBC, a specific request should be made for the required detail to be supplied. No liability will be accepted for any detail or	Jason Watson & Caitlin Lundy Lot 183	Job Number: 133859		Original Plan: Rail	Sheet Name: CONSTRUCTION DETAILS		No. Date: 1 10-08-20	Reason: Initial Consent Plans	Sheet No.: 15
YOUR HOME. YOUR WAY.	P: +64 3 342 7788	construction not covered in these drawings and/or carried out by persons other than the designer producing these documents.	Beach Grove, Kaiapoi	Sales: L Caldwell	Drawn: M Glynn	QS: W Xian	Print Date: 16/09/2022	Scale: As Shown @ A3			of 22 sheets

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Where windows extend to soffit, flashing tape is to be fixed prior to ribbon board being fixed to framing.


> WAIMAKARIRI DISTRICT COUNCIL Plans and specifications APPROVED in accordance with the Building Act 2004, clause 49 and the Building Regulations 1992, Clause 3 BC221027 15/09/2022 staceyg

Sill tape to be turned up over trimmer stud 200mm min.


Sill tape to be turned up over trimmer stud 150mm min.


Sill tape to be continuous along entire sill

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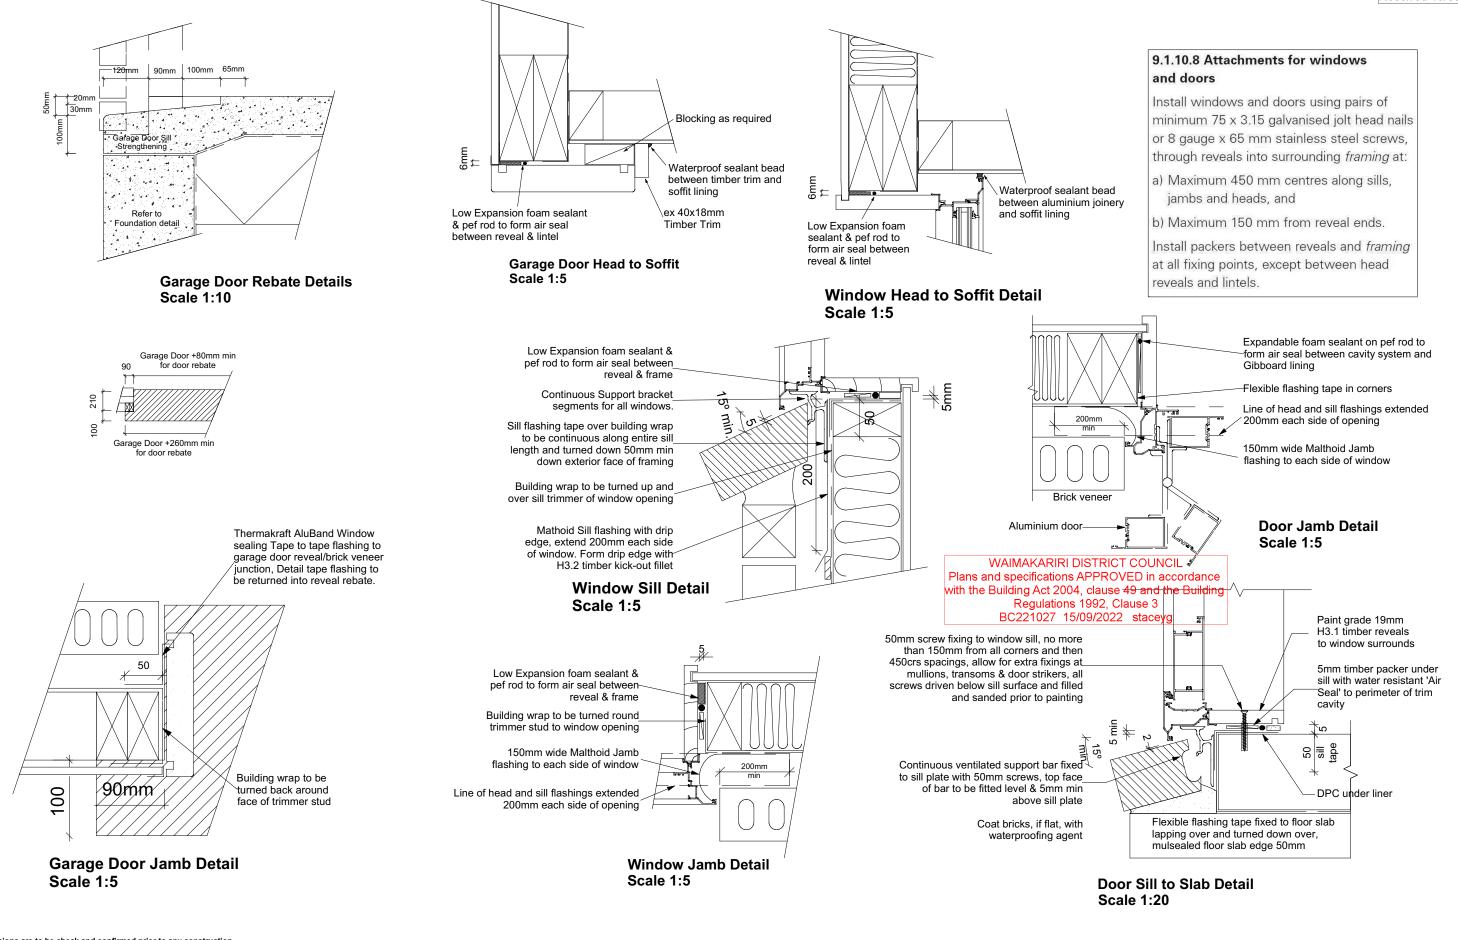


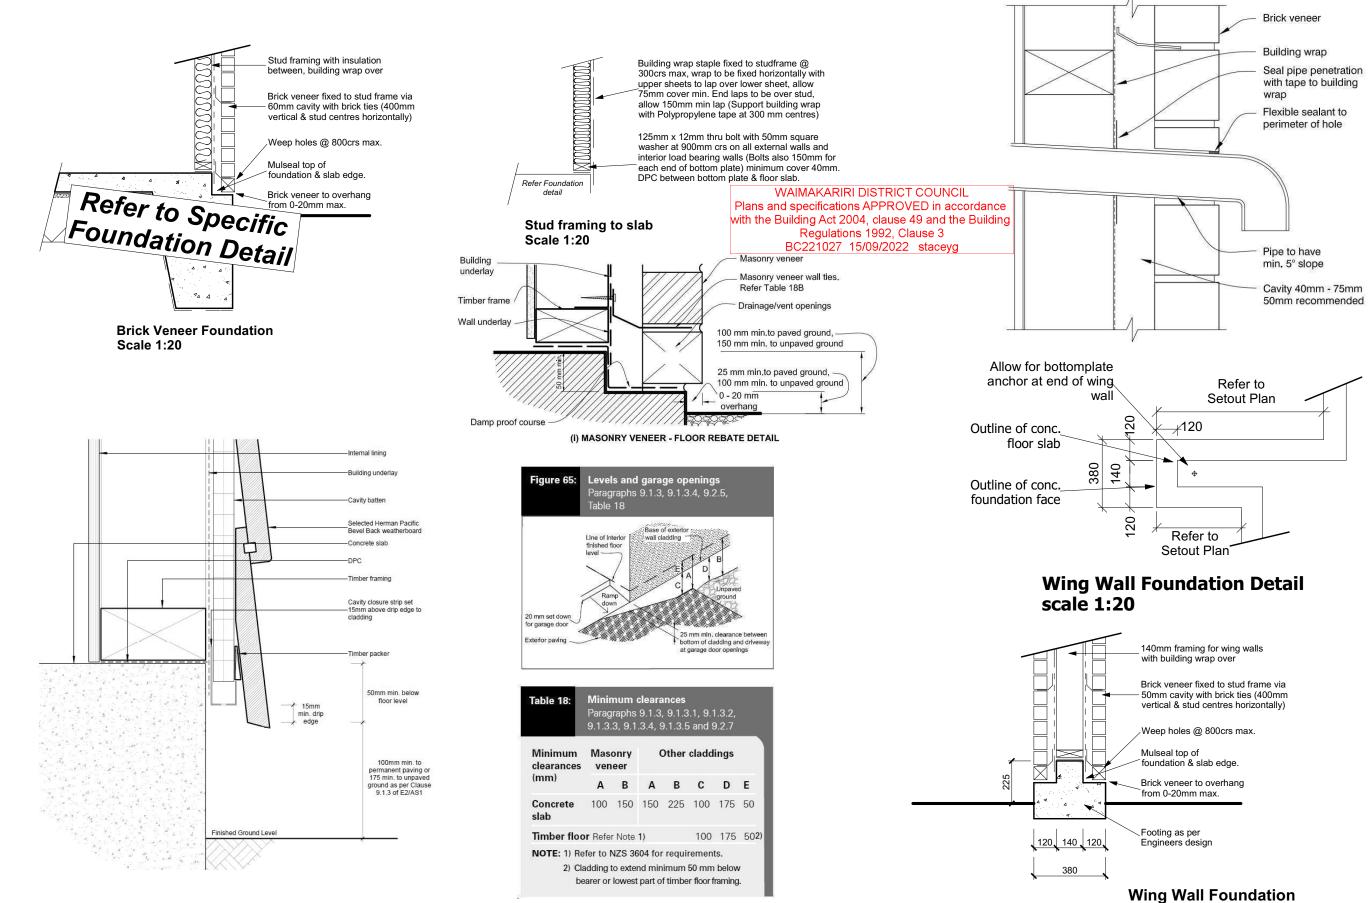	140mm framing for wing walls with building wrap over
	Brick veneer fixed to stud frame via 50mm cavity with brick ties (400mm vertical & stud centres horizontally)
/	Weep holes @ 800crs max.
/	Mulseal top of foundation & slab edge.
_	Brick veneer to overhang from 0-20mm max.

Scale 1:20
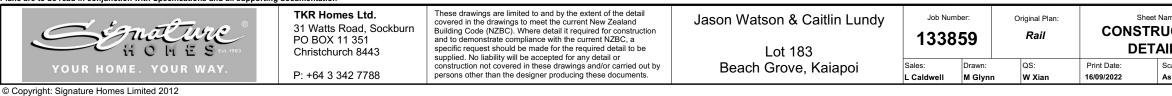
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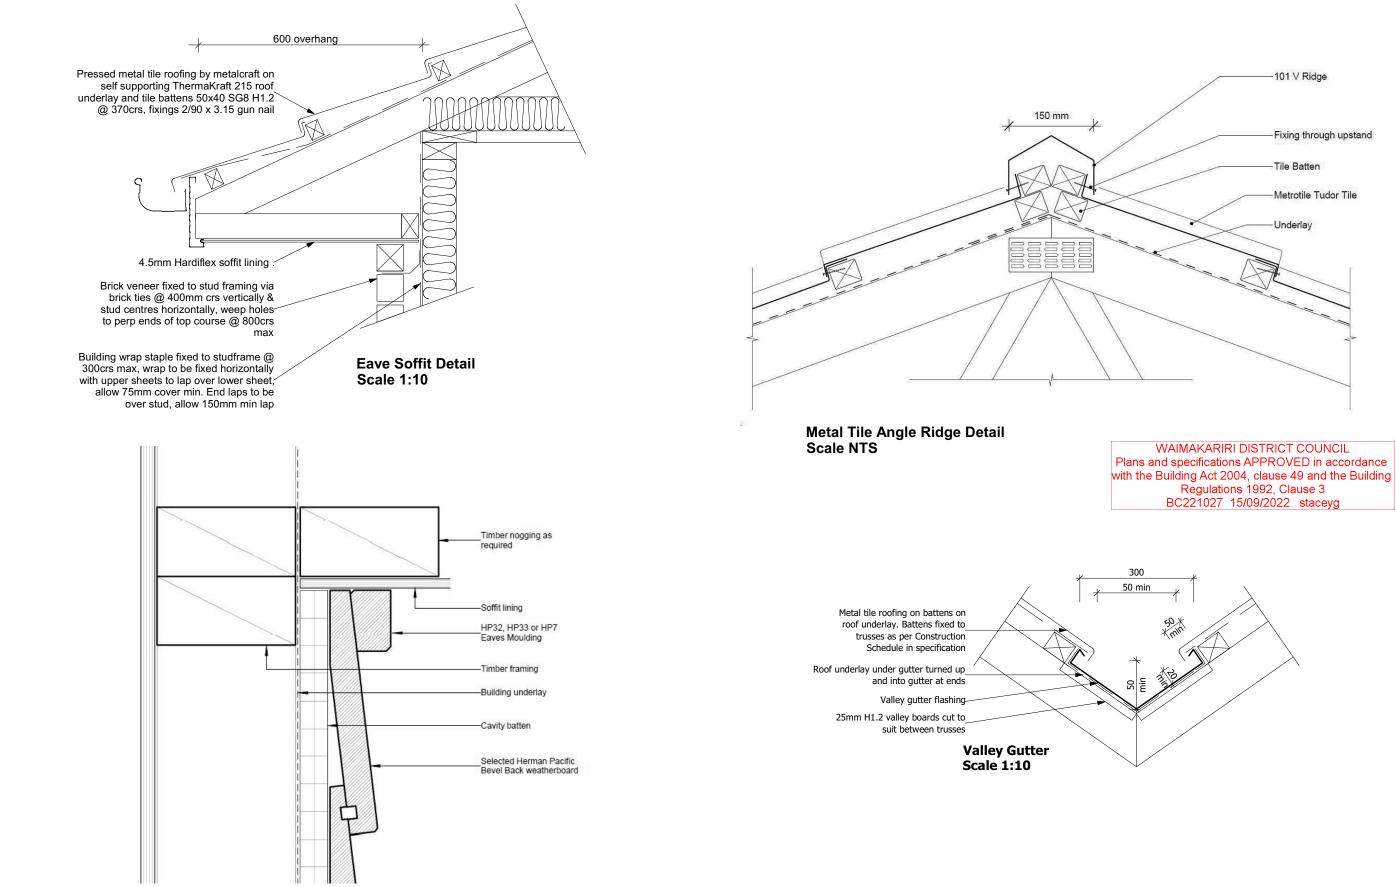
CONSENT ISSUED BC221027 - Page 26 of 31

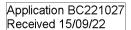

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in O by it S tar. 1943	TKR Homes Ltd. 31 Watts Road, Sockburn PO BOX 11 351 Christchurch 8443	These drawings are limited to and by the extent of the detail covered in the drawings to meet the current New Zealand Building Code (NZBC). Where detail it required for construction and to demonstrate compliance with the current NZBC, a specific request should be made for the required detail to be supplied. No liability will be accepted for any detail or	Jason Watson & Caitlin Lundy Lot 183	Job Num 1338		Original Plan: Rail	CONS	Sheet Name: STRUCTION ETAILS	No. Date: Reason: 1 10-08-2022 Initial Consent Plans	Sheet No.: 17
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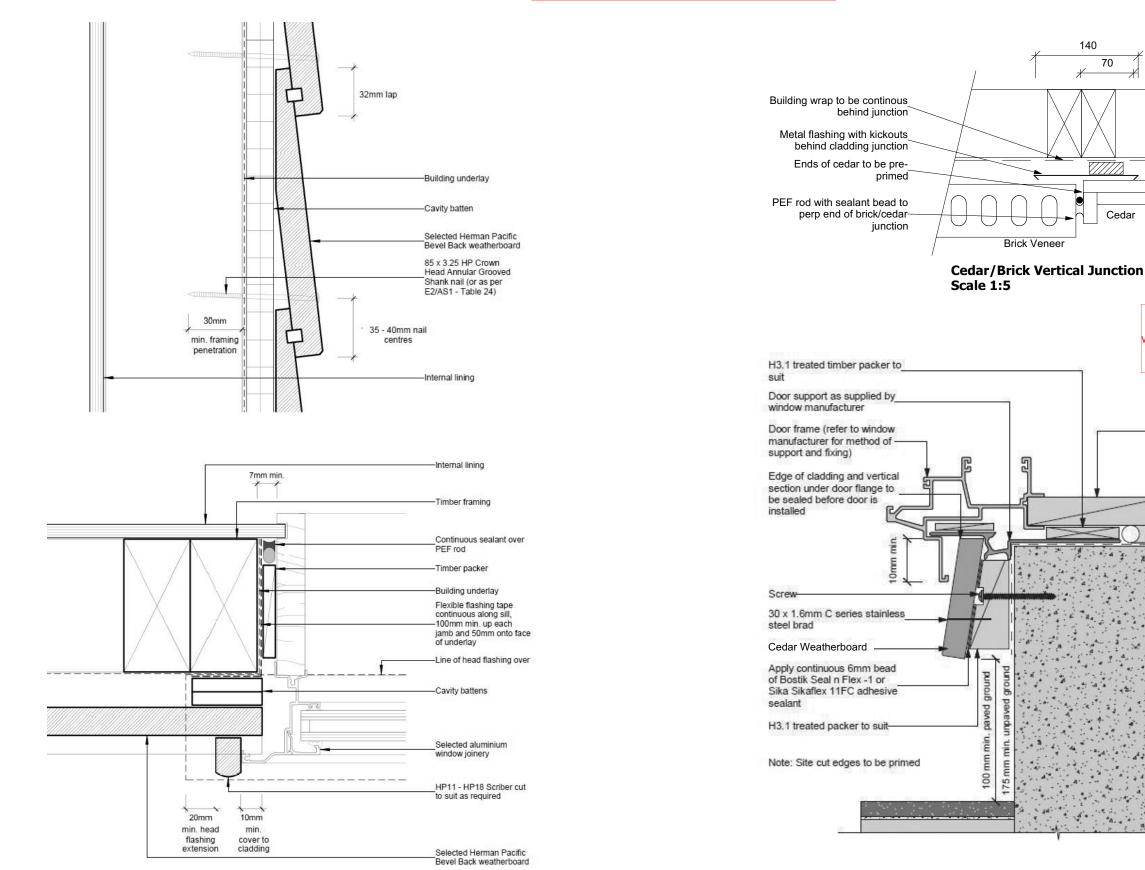
CONSENT ISSUED BC221027 - Page 27 of 31



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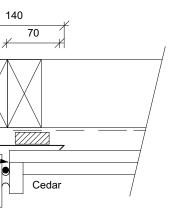
Senature	TKR Homes Ltd. 31 Watts Road, Sockburn PO BOX 11 351 Christchurch 8443	These drawings are limited to and by the extent of the detail covered in the drawings to meet the current New Zealand Building Code (NZBC). Where detail it required for construction and to demonstrate compliance with the current NZBC, a specific request should be made for the required detail to be	Jason Watson & Caitlin Lundy		Job Number: 133859		Sheet Name: CONSTRUCTION DETAILS		No. Date: Reason: 1 10-08-2022 Initial Consent Plans	Sheet No.: 18
YOUR HOME. YOUR WAY.	P: +64 3 342 7788	supplied. No liability will be accepted for any detail or construction not covered in these drawings and/or carried out by persons other than the designer producing these documents.	Lot 183 Beach Grove, Kaiapoi	Sales: L Caldwell	Drawn: M Glynn	QS: W Xian	Print Date: 16/09/2022	Scale: As Shown @ A3		of 22 sheets

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YOUR HOME. YOUR WAY.	TKR Homes Ltd. 31 Watts Road, Sockburn PO BOX 11 351 Christchurch 8443	These drawings are limited to and by the extent of the detail covered in the drawings to meet the current New Zealand Building Code (NZBC). Where detail it required for construction and to demonstrate compliance with the current NZBC, a specific request should be made for the required detail to be	Irrent New Zealand required for construction e current NZBC, a e required detail to be or any detail or ings and/or carried out by Beach Grove, Kajapoj	Job Number: Original Plan: 133859 <i>Rail</i>		Sheet Name: CONSTRUCTION DETAILS		No. Date: Reason: 1 10-08-2022 Initial Consent Plans	Sheet No.: 19	
	P: +64 3 342 7788	supplied. No liability will be accepted for any detail or construction not covered in these drawings and/or carried out by persons other than the designer producing these documents.		Sales: L Caldwell	Drawn: M Glynn	QS: W Xian	Print Date: 16/09/2022	Scale: As Shown @ A3		of 22 sheets
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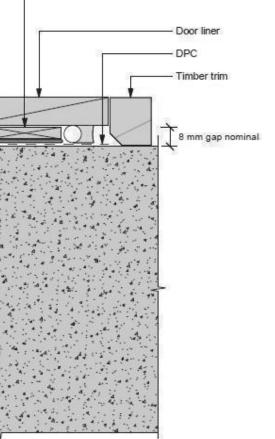



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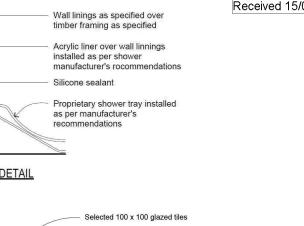
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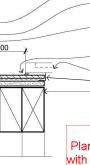





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it O M JE S EL 1983	TKR Homes Ltd. These drawings are limited to and by the extent of the detail covered in the drawings to meet the current New Zealand Building Code (NZBC). Where detail it required for construction and to demonstrate compliance with the current NZBC, a specific request should be made for the required detail to be supplied. No liability will be accepted for any detail or	Jason Watson & Caitlin Lundy Lot 183	Job Number: Original Plan: 133859 Rail		Sheet Name: BATHROOM DETAILS		No. Date: Reason: 1 10-08-2022 Initial Consent Plans		Sheet No.: 20		
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Bodon Grovo, Malapon	L Caldwell	M Glynn	W Xian


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4, clause 49 and the		3				
1992, Clause 3						
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		Trus	ss Fixing	gs		
		A = 47x90	Joist Hanger			
		B = 47x12	0 Joist Hange	r		
		C = CT200	(pair)			
		D = 47x19	0 Joist Hange	r		
		E = 95x16	5 Joist Hange	r		
		F = SH-14	0 Split Hanger			
		G = SH-18	0 Split Hange	·		
		H = SH-22	0 Split Hanger			
		J = 2x6kN	Strap (12kN)			
		K = 6kN S	trap			
		L = Multig	rip (single)			
		M = Multig	rips (pair)			
		N = Nailor	Plate (240x11	0x1)		
		P = 16kN				
		Q = 9kN P	ack			
8860		S = CPC 4	0 Single Cleat	:		
			0 Short (pair)			
			0 Single Cleat	:		
		V = 16kN	-			
			ers Design			
			dicated, all spe	cified		
	truss fixir	ngs are to u	se L/Lok produ	ct nail		
			17 - 14g Hex H MiTek On-site (
	All tru	uss to frame	fixings require	2		
			.15dia skew na			
			indicated as a			
			logs for cross jo nails for butt jo			
	Fixings	shown are	for fixing trusse	es to		
			ther point load the framing st			
	top plat	e, stud to b	ottom plate, bo	ttom		
1710			the responsibi draughtsman.			
			tated on this la			
			utside the scop the architect /	be of		
	draugh	tsperson is	responsible for r the loads to tl			
	uesig		und.			
	s	now Zone:	Christchurch	(N4)		
	\ \	Wind Area:	High			
	тс	Restraints:	400 mm			
	Roo	of Material:	Metal Tiles			
		Roof Pitch:	25.00 °			
	Sno	w Altitude:	100.000 m			
	Design Wi	nd Speed:	44.0 m/s			
	BC I	Restraints:	600 mm			
	0-111	a Motori-L	Standard Plas	ster		
ired at 1800mm centres	Cellin	g Material:	Board 13mm			
stic loads	Ground S	now Load:	0.900 kPa			
	Trus	s Centres:	900 mm			

Application BC221027
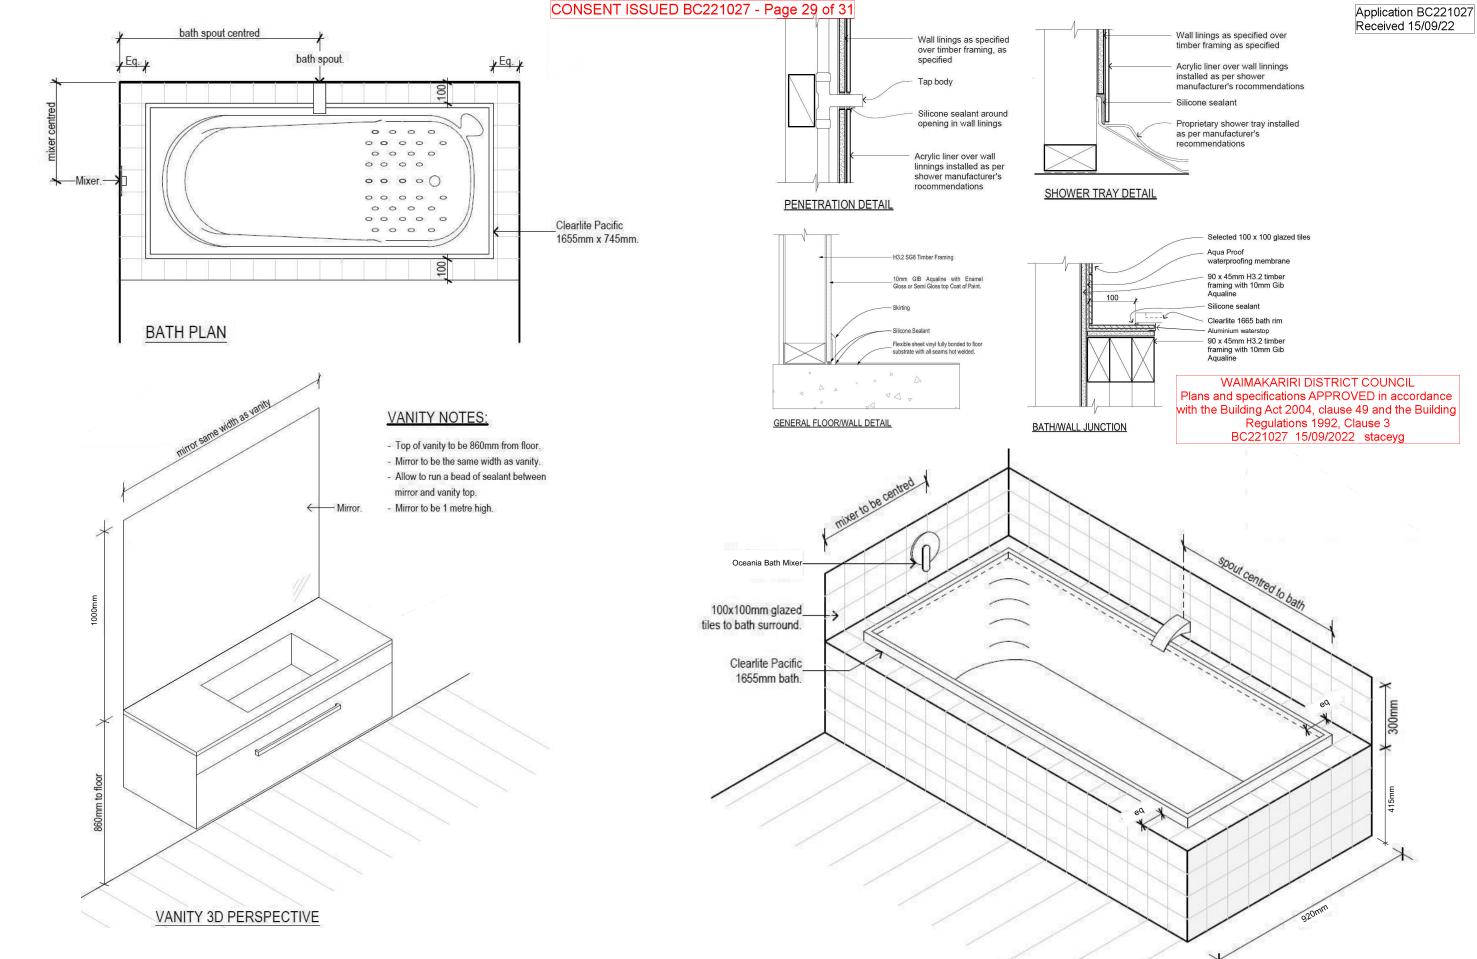
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TRUSS DESIGN			No. 1	No. Date: Reason: 1 10-08-2022 Initial Consent Plans		21
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Beach Grove, Kaiapoi

Lot 183

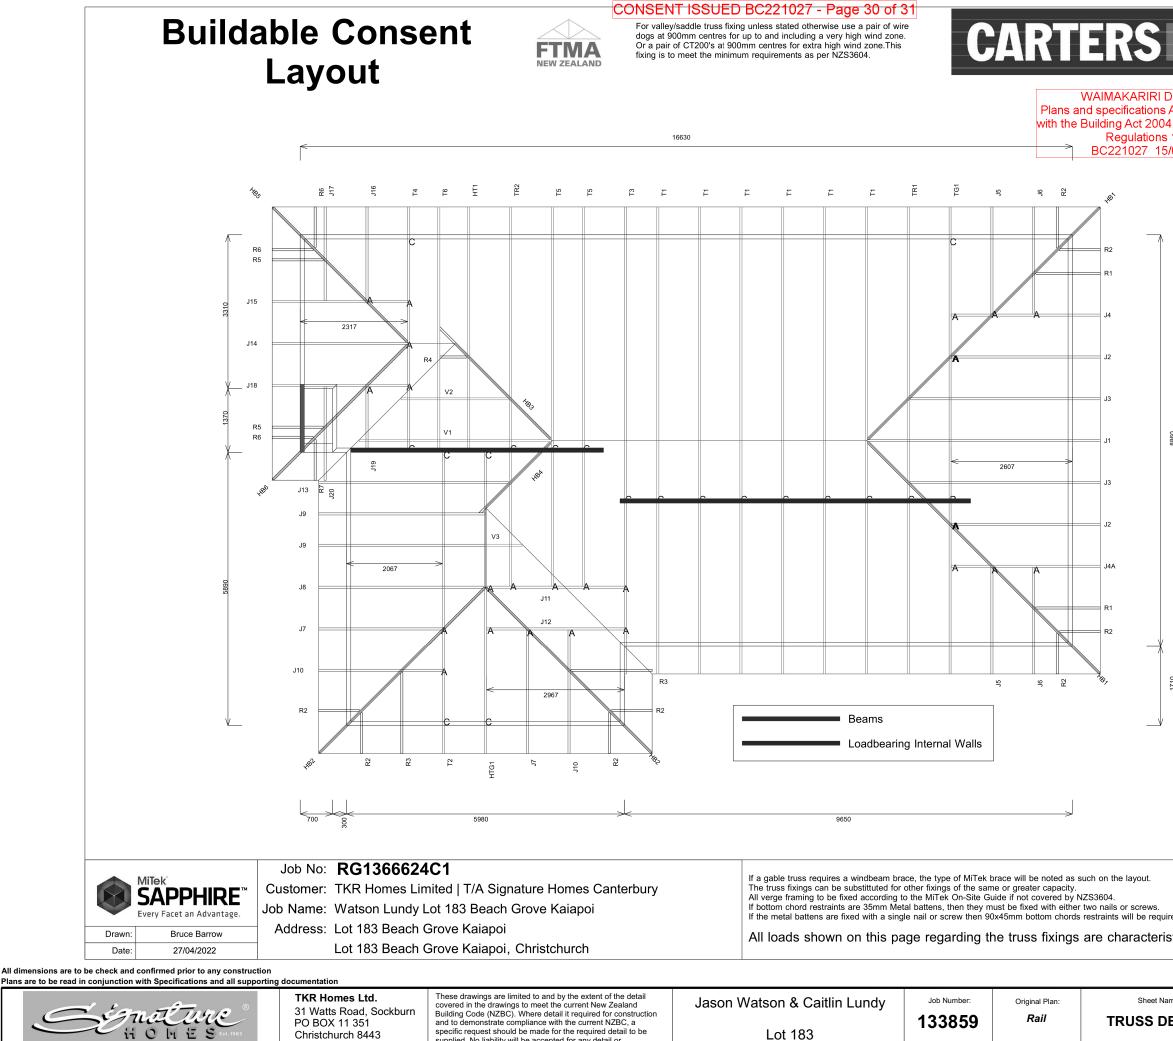QS: Drawn M Glynn W Xian L Caldwel

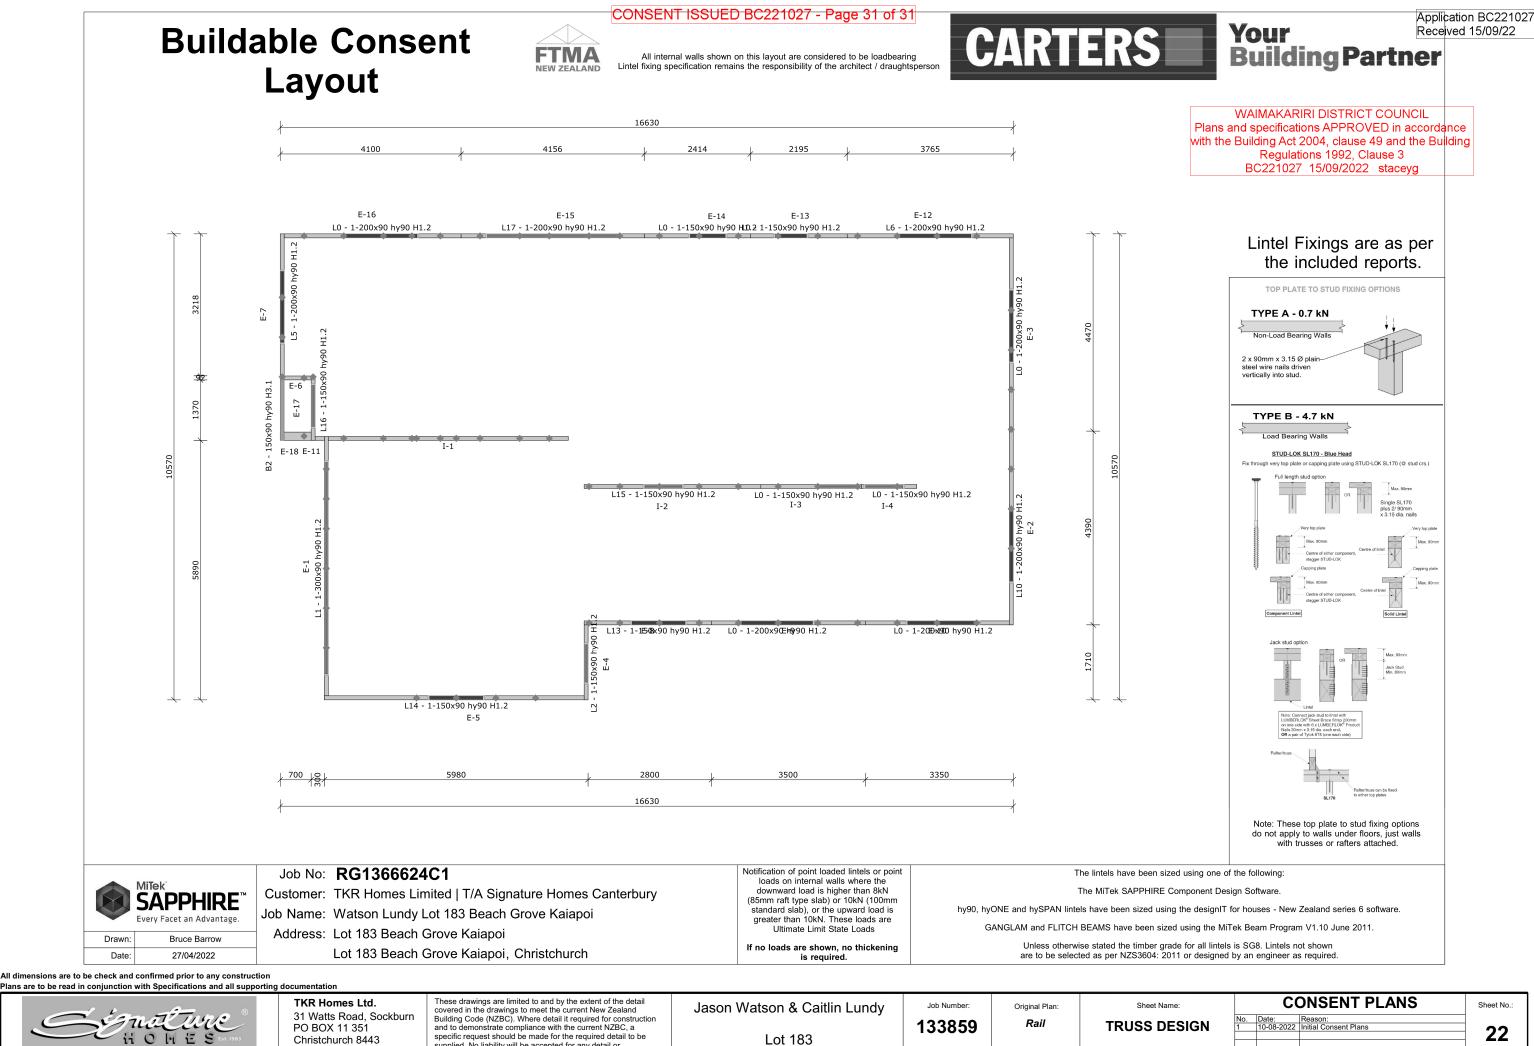Print Date

16/09/2022

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11	or	desi	gned	by	an	engineer	as	required	•

Sheet Name: TRUSS DESIGN				Sheet No.:	
			<u>No.</u> 1	Reason: Initial Consent Plans	22
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