

addition addition

North 3D Sketch

South 3D Sketch

Sketches for Overall Building form not for measuring

145 Mt Pleasant Road Mount Pleasant

Parcel ID: 3524834 Appellation: Lot 8 DP 17670 Location: Mount Pleasant

Climate Zone: 5 Earthquake Zone: Zone Z Exposure Zone: Zone C Lee Zone: No Rainfall Range: 30 - 40 Wind Region: A Wind Zone: Very High

Zone Information

w Entry Extension for Site Coverage - New deck area at level 1 is under level 2 deck Note No Change to Existing Roof Planes to effect Existing Recession Planes Approvals: LIN/92/37NCA 145 Mt Pleasant Rd Site Area 1169M² New Extension areas for site coverage 03.00m² Level 3 Extension-entry 03.10m² Total Site Coverage Extension Building Areas New Construction 29.50m² Level 1-Kitchen 09.50m² Level 1 Deck- Extension 06.50m² Level 2-Bathroom 05.50m² Level 3-Entry 51.00m² Total New Construction Work Existing Deck and Building Area (Footprint) Site Plan

New Total Deck and Building (Footprint) 230.0m²/1169=20% Site Coverage (note figures have been rounded up)

Level One Extension unde

Level Two Extension under Existing foot print

5,500



Ecan Contours

		Louis Contours		
₹oa		A STATE	Rating Units: 229020	06000
d	E CA		Local Council	Christchu Council
-4	143	一种的代码等	Valuation No	22902060
F 11		No. of Contrast of	Street Address	145 Mt Pl
		10	Locality	Mt Pleasa
	145		Legal Descriptions	Lot 8 DP 1
	I make	15 to 10 10 10 10 10 10 10 10 10 10 10 10 10	Rating Hectares	0.12
1	-	THE RESERVE	Capital Value (\$)	470,000
			Land Value (\$)	280,000

Ecan Info

Local Council	Christchurch City Council
Valuation No	2290206000
Street Address	145 Mt Pleasant Road
Locality	Mt Pleasant
Legal Descriptions	Lot 8 DP 17670
Rating Hectares	0.12
Capital Value (\$)	470.000

CHECKLIST 17 Returns 1-3m in length to reduce visicity along the six tence and provide intermediate impoundment. Sit fence with returns and support wire

Required down hill of building + locally

operation and the

Slape steepness %	Slope length	spacing of	Sitt fence length
	(m) (maximum)	returns (m)	(m) (maximum)
Flatter than 2%	Unlimited	N/A	Unlimited
2 - 10%	40	60	300
10 - 20%	30	50	230
20 - 33%	20	40	150
33 - 50%	15	30	75
> 50%	6	20	40
77/77	Compaded societi Trend gedadate 200nn minimum		Actions reporture Magnet of geotradie 200mm deglin of stancy
	Cros	s - section	
Good and a shift was shreaded in a shift was shift and the shift was shift	over cross section own hill of new four	building ndation	+ locally fo
Required do	or cross section were hill of new four men installed to prefer a stable seem impossible or finish planning existing sw we hill of	building ndation	+ locally fo

10 Section A Part II-C Entry 11 Section B 12 Engineering Details 13 Opening Schedule Lintel Fixin... 14 Construction Details 15 Electrical Finishes Plans 16 Finishes + Wetwall details

SHEET INDEX 01 Site Location Information+ Site.. 02 Existing Floor Plans 03 Pole Foundation-Services- Plan 04 Floor Plans Scope of Work-Br... 05 O/A Floor/Deck Joist Plan 06 Elevations East North- Plan D... 07 Elevations West South-E2 Mat. 08 General Section- 1:50 09 Section A Part I

DWELLING Alterations+ Recladd for Greg+ Ngaio Bell 145 Mt Pleasant

Road Mt Pleasant Christchurch 8081 Postal

Site Information:
CT:CB576/22
Lot: 8
DP-17670
Area:1169M*
Nett Area: NA
Wind:A-V High-50m/s
EQ Zone: 3
Altitude:120.0M
Snow:N4-1.5RPa
Rainfall:30-30mm
Soil: Geo Report
sosure:C. 900M from Sea
Planning Zone:
Planning Zone: Planning Zone: R. Hills -Slope

Instability Management. Site Coverage: New 22%

49 Coolspring Way Christchurch 8051. 0274362996 grant@gmad.co.nz

© The designs contained on this drawing are copyright. The Client has the right to use for the site noted herein only.

Date Sheet No.
BC 14/11/2023 01
Job Ref. or 16

5,360

Contractor shall verify all dimensions on site

All drawings released prior to building consent being issued are deemed preliminary & subject to change without notice. Work shall only commence with a Council stamped consented copy of drawings



Postal

Site Information:
CT:CB576/22
Lot: 8
DP:17670
Area:1165M*
Nett Area: NA
Nett Area: NA
Nind:A-V High-50m/s
EG Zone: 3
Altitude:120.0M
Snow:N4-1.5kPa
Rainfall:30-30mm
Soil: Geo Report
Exposure: C-900M from Sea
Planning Zone:
R. Hills -Slope
Instability Management.
Site Coverage:
New 22%

49 Coolspring Way Christchurch 8051. 0274362996 grant@gmad.co.nz © The designs contained on this drawing are copyright. The Client has the right to use for the site noted herein only.

Sheet No.

SHEET INDEX 01 Site Location Information+ Site.. 02 Existing Floor Plans

03 Pole Foundation-Services- Plan 04 Floor Plans Scope of Work-Br...

Poles-Foundation

UPVC Pipe Sizing & Gradients (min.)

Sink 50mmØ-1:40 gradient Tub 40mmØ-1:30 gradient Shower 40mmØ-1:40 gradient Vanity 40mmØ-1:40 gradient Bath 40mmØ-1:40 gradient WC 100mmØ-1:60 gradient

AAV Air admittance valve to waste trap Accessible in joinery fitting or roof/sub floor above space

Floor Waste 40mmØ-1:40 gradient to to safe location to exterior with verim flap

HWC Drain 20mmØ to open air in safe location

HWC Tray40Ø uPVC. Run to safe location to exterior with verim flap

Pipe Supports UPVC Waste pipes shall be supported Horizontal:

up to 50 dia-500 crs up to 100 dia 1.0m crs

up to 50 dia-1.0mcrs up to 100 dia 1.2m crs

Drainage Plumbing Notes NZBC

100mmØ UPVC sewer at 1:80 min. grade; ______ Indicates access point 100mmØ UPVC stormwater at 1:120 min. grade

Drainage Runs shown Indicative allow to provide as Built drawings with PS3. Drainage installed to: NZBC G13 /AS1- Sewer NZBC E1/AS1- Stor Plumbing to: NZBC G13 / AS1

position
HWC Tray 40Ø uPVC. Run to safe location to exterior with verim flap

Polywrap to be installed to service penetrations to footings & slab to ensure 6mm clearance

Contractor shall verify all dimensions on site

All drawings released prior to building consent being issued are deemed preliminary & subject to change without notice. Work shall only commence with a Council stamped consented copy of drawings

SHEET INDEX 01 Site Location Information+ Site. 02 Existing Floor Plans

03 Pole Foundation-Services- Plan 04 Floor Plans Scope of Work-Br...

05 O/A Floor/Deck Joist Plan 06 Elevations East North- Plan D...

07 Elevations West South-E2 Mat. 08 General Section- 1:50

09 Section A Part I 10 Section A Part II-C Entry

11 Section B

12 Engineering Details

13 Opening Schedule Lintel Fixin... 14 Construction Details 15 Electrical Finishes Plans

16 Finishes + Wetwall details

Construction + Approved BC
RPI Update
BC Application
Fee Take Officorings
Transa Design - Engineer
Client
Perlinninary Design
Issue
Drawling Scale as
noted at A1 Size: Half
Scale at A3
i.e. 1:100 at A1 = 1:200
at A3

DEMECH LIMIC

DWELLING Alterations+ Recladd for Greg+ Ngaio Bell 145 Mt Pleasant

Road Mt Pleasant Christchurch 8081


Postal

Site Information:
CT:CB576/22
Lot: 8
DP:17670
Area:1169M*
Nett.Area: NA
Wind:A-V High-50m/s
EQ Zone: 3
Altitude:120.0M
Snow:M4-1.5RPa
Rainfall:30-30mm
Soil: Geo Report
osure:C. 900M from Sea
Planning Zone:
R. Hills:-Slope
stability Management. Instability Management. Site Coverage: New 22%



49 Coolspring Way Christchurch 8051. 0274362996 grant@gmad.co.nz

Date Sheet No.
BC 14/11/2023 03
Job Ref. of 16

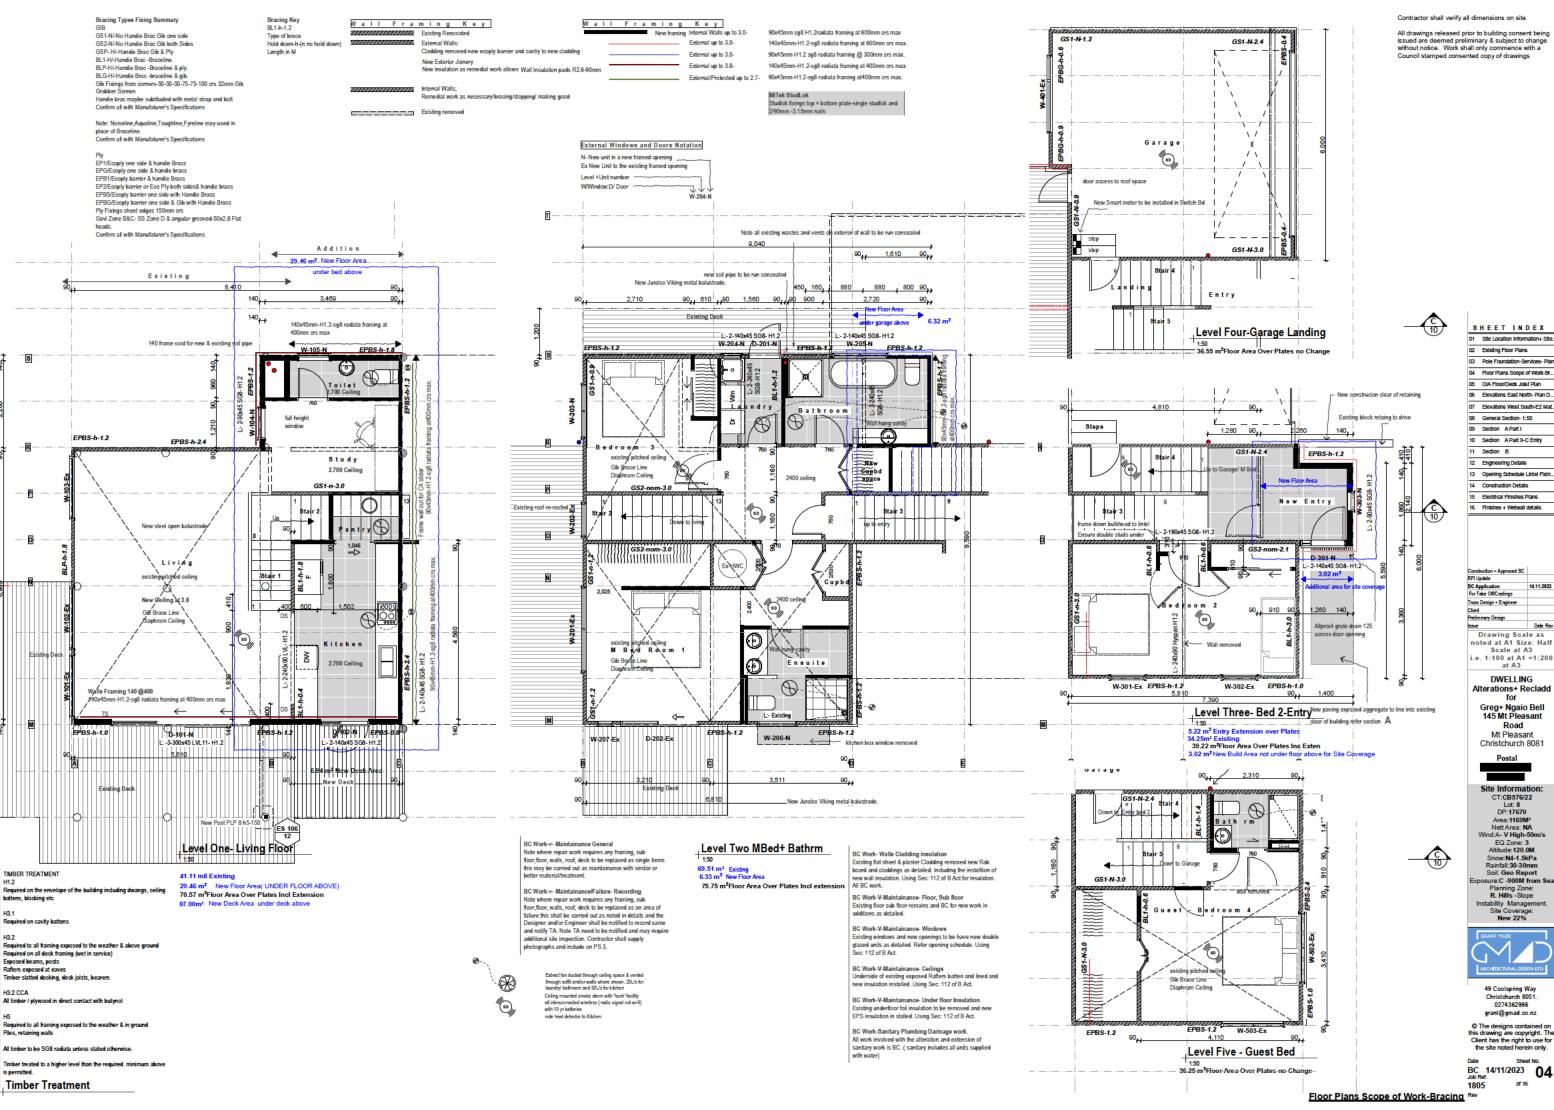

03 Pole Foundation-Services- Pla 04 Floor Plans Scope of Work-Br. 05 O/A Floor/Deck Joist Plan 06 Elevations East North- Plan D... 07 Elevations West South-E2 Mat

08 General Section- 1:50 09 Section A Part I 10 Section A Part II-C Entry 11 Section B

12 Engineering Details 13 Opening Schedule Lintel Fixin. 14 Construction Details 15 Electrical Finishes Plans

16 Finishes + Wetwall details

14.11.2023 BC Application For Take OffiCostings Truss Design + Engineer Client Preliminary Design Date Rev

Drawing Scale as noted at A1 Size: Half Scale at A3 i.e. 1:100 at A1 =1:200 at A3

DWELLING Alterations+ Recladd

Greg+ Ngaio Bell 145 Mt Pleasant Mt Pleasant Christchurch 8081

Postal

Site Information:
CT:CB576/22
Lot: 8
DP:17670
Area:1169MF
Nett Area: NA
Wind:A - V High-50m/s
EQ Zone: 3
Altitude:120.0M
Snow:N4-1.5kPa
Rainfall:30-30mm
Soil: Geo Report ure:C -900M from Sea Planning Zone: R. Hills -Slope Instability Managen Site Coverage: New 22%



49 Coolspring Way Christchurch 8051. 0274362996 grant@gmad.co.nz

BC 14/11/2023 04 1805 of 16

Level One- Living-Floor Joists

inds
V Main Vent 80mmØ
P 80mmØ colorsteel downpipes
T Gully trap. Install all with removable grate aunched concrete surround 50mm above surface level

40Ø uPVC. Run to safe location to

HWC Drain 20mmØ to open air in safe location

Pipe Supports UPVC Waste pipes shall be su ste pipes shall be supported


up to 50 dia-500 crs up to 100 dia 1.0m crs

up to 50 dia-1.0mcrs up to 100 dia 1.2m crs

HWC Trav40Ø uPVC. Run to safe location to exterior

Contractor shall verify all dimensions on site

All drawings released prior to building consent being issued are deemed preliminary & subject to change without notice. Work shall only commence with a Council stamped consented copy of drawings

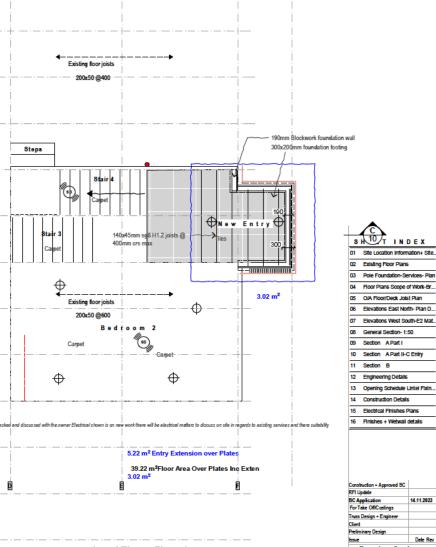

at 1500 crs max + balusters at 99 crs

New Juralco Viking metal balustrade

Ex 150x25mm hardwood decking (grooves face down)

To replace existing decking and for new decking areas

SS lumberlok strap 0.9x19 at external corne

2 pairs of SS-CPC 40 at perimeter edge (4 off).

1 pair SS-CPC 40 at inside joist. (2 off).

At exterior corner use SS-CPC 80. (2 off)

Existing/new 190 x 45 joists at 400 crs

ensure that there is doublejoists

blocking to perimeter for balustrade

side of existing piles

All in accordance with Juralco Viking Balustrade system Spec. & producer statement

fixing

All timber deck framing SG8 H3.2

Deck Framing

B- 50 New Exterior Balustrading

Solid blocking at 400 crs with:

Level Three -Floor Joists

Date Rev Date Rev
Drawing Scale as
noted at A1 Size: Half
Scale at A3
i.e. 1:100 at A1 =1:200
at A3 DWFLLING Alterations+ Recladd for

Greg+ Ngaio Bell 145 Mt Pleasant Road Mt Pleasant Christchurch 8081 Postal

Site Information:
CT:CB576/22
Lot: 8
DP:17670
Area:1169M²
Nett Area: NA
Wind:A-V High-50m/s
EQ Zone: 3
Altitude:120.0M
Snow:N4-1.5ikPa
Rainfall:30-30mm
Soil: Geo Report
losure:C -900M from Sea
Planning Zone:


Planning Zone: R. Hills -Slope Instability Management Site Coverage: New 22%



49 Coolspring Way Christchurch 8051. 0274362996 grant@gmad.co.nz


© The designs contained on this drawing are copyright. The Client has the right to use for the site noted herein only.

Sheet No. BC 14/11/2023 05 1805 of 16

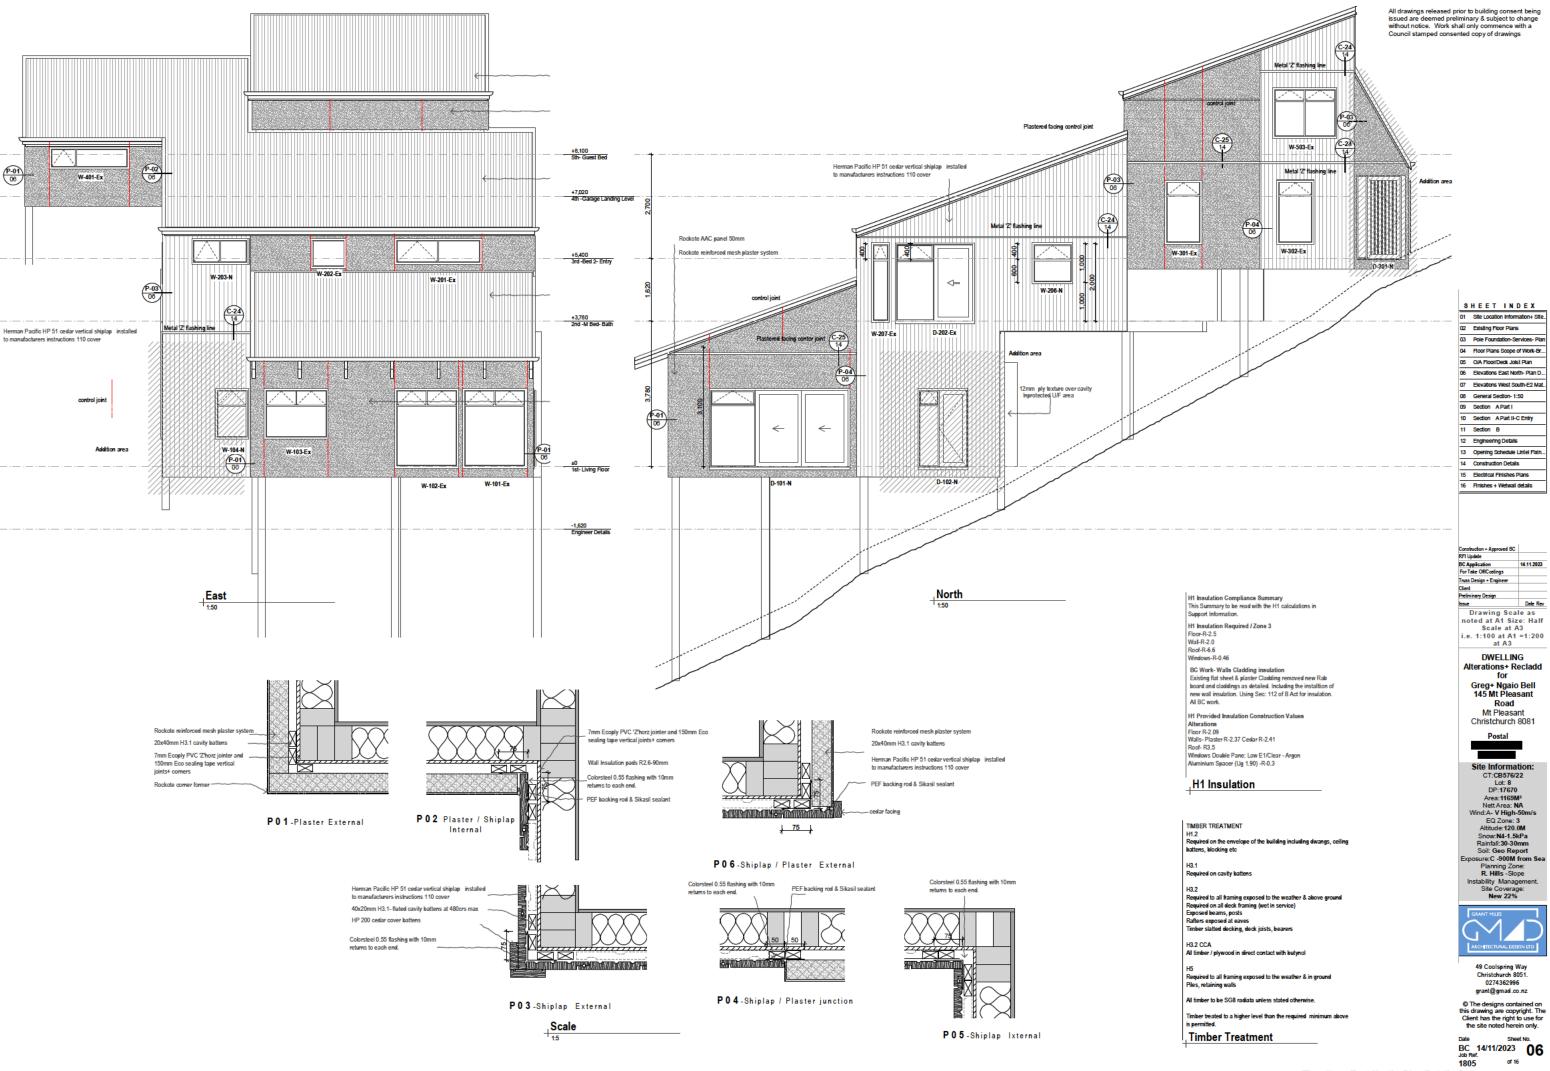

All drawings released prior to building consent being issued are deemed preliminary & subject to change without notice. Work shall only commence with a Council stamped consented copy of drawings

Date Sheet No.
BC 14/11/2023 06
Job Ref. of 16

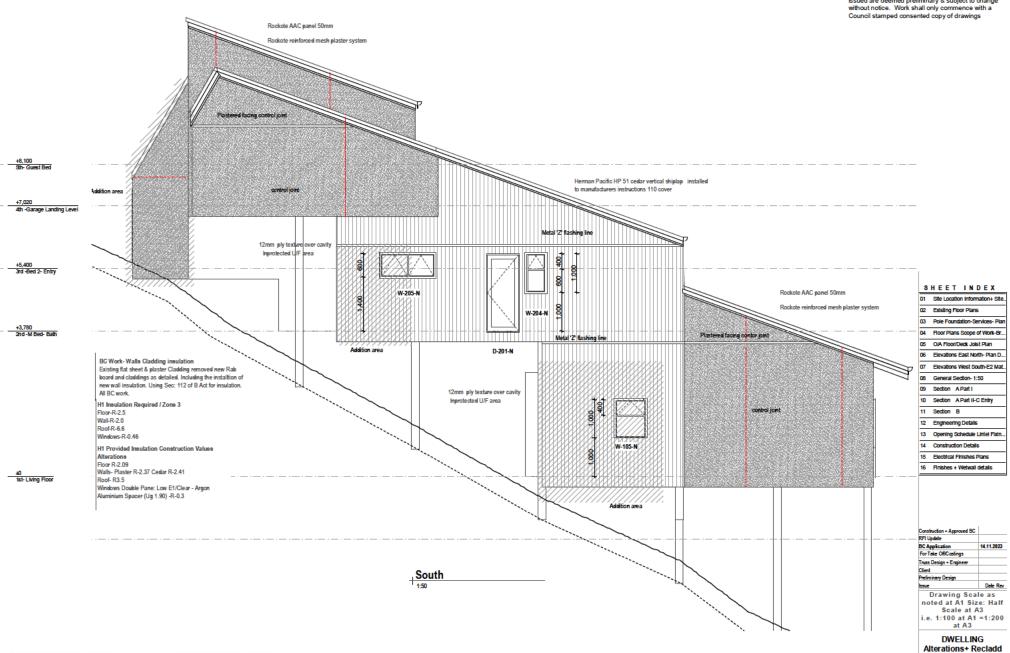

External Moisture Risk Matrix This Risk Maric is based on the DBH sublication "Esternal moisture - a guide to using the risk matric". It should be used in conjunction with the Guide which can be described from the Ministry of Business, Innovation and Employment values. Philosophy of the Rick Accessment Marin The development of the not assessment approach taken in E2IAS1 is based on a simple concept called "the 4Ds" to describe the basic principles of water incompenent in buildings. The 4Ds are Defaction: Kapping water away from parantal entry points. Definings Providing means of remaining water that does enser. Doying Albeing any sense ining moleture to be removed by sent Durability. Providing materials with appropriate durability. How to Use this Matrix Complete the risk factors for each external face in your design. At the bottom of the table your total risk score will be shown Very High Vary High = 2 OLow=0 O Medium = 0 Nos sigu cos sovia O High = 1 Note and analysis A. Wind Zone: O Extra High = 2 [7] □ High • 2 ■ Very High = 4 C. Roof/Well Intersection Design: O Very High = 5 Wary High = 5 OLew=0 □ High = 3 Wary High = 6 or Fing, box vincous ○ Very Hgh = 8 O High = 4 Display Results Table Download Results Table (HTML) Timber weatherboard - all types
Timber weatherboard - bevel backed.
Fine cement weatherboards
Various profile measured - companied and own
Various profile measured - companied only
Various profile measured - companied only
Various lamber board and behave.
Fine benefit phase formed finish (avoign truce
EIPS

EIPS

E2 matrix

P-03 06

P-01 06

C-24

W-303-N

West

DWELLING Alterations+ Recladd for Greg+ Ngaio Bell 145 Mt Pleasant Road Mt Pleasant Christchurch 8081 Postal

SHEET INDEX


Site Information:
CT:CB576/22
Lot: 8
DP:17670
Area:1169M²
Nett Area: NA
Wind:A- V High-50m/s
EQ Zone: 3
Altitude:120.0M
Snow:N4-1.5RPa
Rainfall:30-30mm
Soil: Geo Report
xposure:C-300M from Sea
Planning Zone: Planning Zone: R. Hills -Slope Instability Management. Site Coverage: New 22%



49 Coolspring Way Christchurch 8051. 0274362996 grant@gmad.co.nz

© The designs contained on this drawing are copyright. The Client has the right to use for the site noted herein only.

Date Sheet No.
BC 14/11/2023 07
Job Ref. or 16

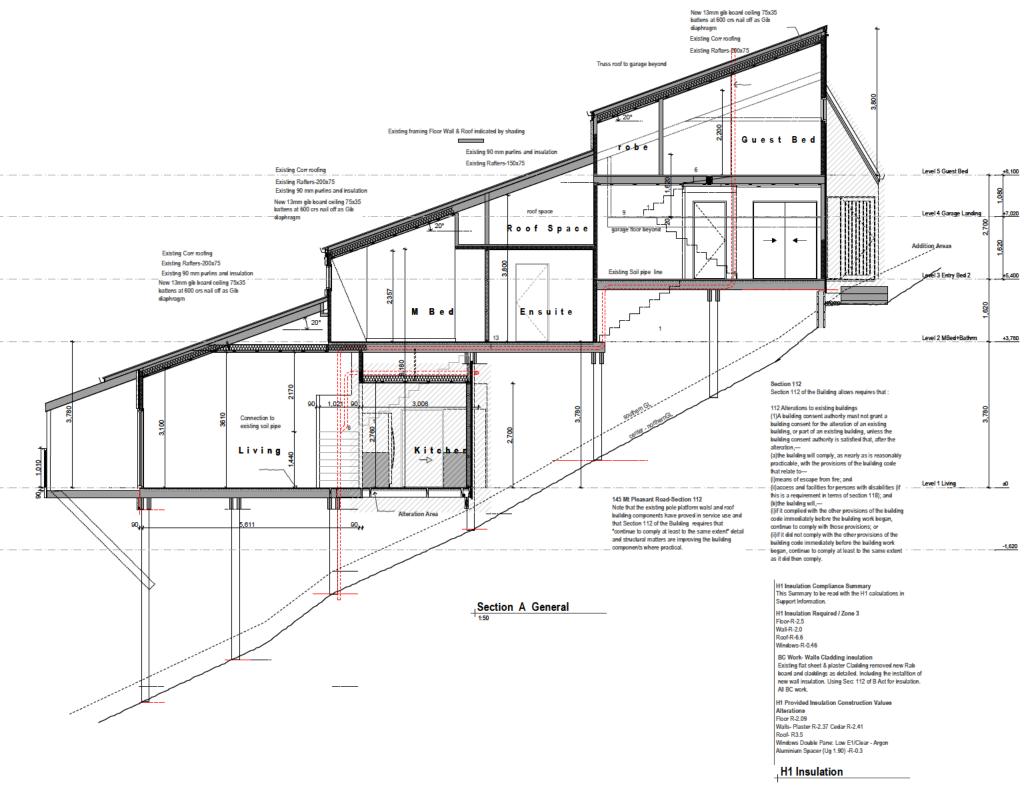

BC Work-v- Maintainance General

BC Work-v- Maintainance/Failure- Recording BC Work-- Maintamanoelf-allure- Necording Note where repair work requires any framing, sub floor, floor, walls, not, deck to be replaced as an area of failure this shall be carried out as noted in details and the Designer and/or Engineer shall be notified to record same and notify TA. Note TA need to be notified and may require additional site inspection. Contractor shall supply photographs and include on PS 3.

BC Work-Walls Cladding insulation Existing flat sheet & plaster Cladding removed new Rab board and claddings as detailed. Including the installtion of new wall insulation. Using Sec: 112 of B Act for insulation. All BC work.

BC Work-V-Maintainance- Floor, Sub floor Existing floor sub floor remains and BC for new work in additions as detailed.

BC Work-V-Maintainance- Windows Existing windows and new openings to be have new double glazed units as detailed. Refer opening schedule. Using Sec: 112 of B Act.

BC Work-V-Maintainance- Ceilings Underside of existing exposed Rafters batten and lined and new insulation installed. Using Sec: 112 of B Act.

BC Work-V-Maintainance- Under floor Insulation Existing underfloor foil insulation to be removed and new EPS insulation in stalled. Using Sec: 112 of B Act.

BC Work-Sanitary Plumbing Darinage work. All work involved with the alteration and extension of sanitary work is BC. (sanitary includes all units supplied with water)

Contractor shall verify all dimensions on site

All drawings released prior to building consent being issued are deemed preliminary & subject to change without notice. Work shall only commence with a Council stamped consented copy of drawings

SHEET INDEX 01 Site Location Information+ Site..

02 Existing Floor Plans 03 Pole Foundation-Services- Plan

04 Floor Plans Scope of Work-Br... 05 O/A Floor/Deck Joist Plan 06 Elevations East North- Plan D...

07 Elevations West South-E2 Mat.

08 General Section- 1:50 09 Section A Part I

10 Section A Part II-C Entry

11 Section B 12 Engineering Details

13 Opening Schedule Lintel Fixin...

14 Construction Details

15 Electrical Finishes Plans

16 Finishes + Wetwali details

Construction + Approved BC
RFI Update
BC Application
For Take Officionings
Tiness Design - Engineer
Client
Drawling Scale as
noted at A1 Size: Half
Scale at A3
i.e. 1:100 at A1 = 1:200
at A3

DWFI LING

Alterations+ Recladd for Greg+ Ngaio Bell 145 Mt Pleasant Road Mt Pleasant

Christchurch 8081

Postal

Site Information:
CT:CB576/22
Lot: 8
DP::17670
Area:1169M*
Nett Area: NA
Wind:A-V High-50m/s
EQ Zone: 3
Altitude:120.00M
Snow:N4-1.5kPa
Rainfali:30-30mm
Soit: Geo Report
posure:C.-900M from Sea
Planning Zone: Planning Zone: R. Hills -Slope Instability Management. Site Coverage: New 22%



49 Coolspring Way Christchurch 8051. 0274362996 grant@gmad.co.nz

© The designs contained on this drawing are copyright. The Client has the right to use for the site noted herein only.

BC 14/11/2023 08 1805 of 16

General Section- 1:50 Rev

All drawings released prior to building consent being issued are deemed preliminary & subject to change without notice. Work shall only commence with a Council stamped consented copy of drawings

01 Site Location Information+ Site. 02 Existing Floor Plans 03 Pole Foundation-Services- Plan 04 Floor Plans Scope of Work-Br... 05 O/A Floor/Deck Joist Plan 06 Elevations East North- Plan D... 07 Elevations West South-E2 Mat. 08 General Section- 1:50 09 Section A Part I 10 Section A Part II-C Entry 11 Section B 12 Engineering Details 13 Opening Schedule Lintel Fixin... 14 Construction Details 15 Electrical Finishes Plans 16 Finishes + Wetwali details Construction + Approved S.
RFI Update
BC Application
For Take OffiCostings 14.11.2023 For Take Off Costings
Tinas Design - Engineer
Clotet
Defininary Design
ssee
Date Rev
Drawing Scale as
noted at A1 Size: Half
Scale at A3
i.e. 1:100 at A1 = 1:200
at A3

SHEET INDEX

Alterations+ Recladd for Greg+ Ngaio Bell 145 Mt Pleasant Road Mt Pleasant Christchurch 8081 Postal

DWFI LING

Site Information:
CT:CB576/22
Lot: 8
DP:17670
Area:1169M*
Nett Area: NA
Wind:A-V High-50m/s
EQ Zone: 3
Altitude:120.0M
Snow:N4-1.5kPa
Rainfall:30-30mm
Soil: Geo Report
osure:C -900M from Sea
Flanning Zone:


Planning Zone: R. Hills -Slope Instability Management Site Coverage: New 22%



49 Coolspring Way Christchurch 8051. 0274362996 grant@gmad.co.nz

© The designs contained on this drawing are copyright. The Client has the right to use for the site noted herein only.

Sheet No. BC 14/11/2023 09 1805 of 16

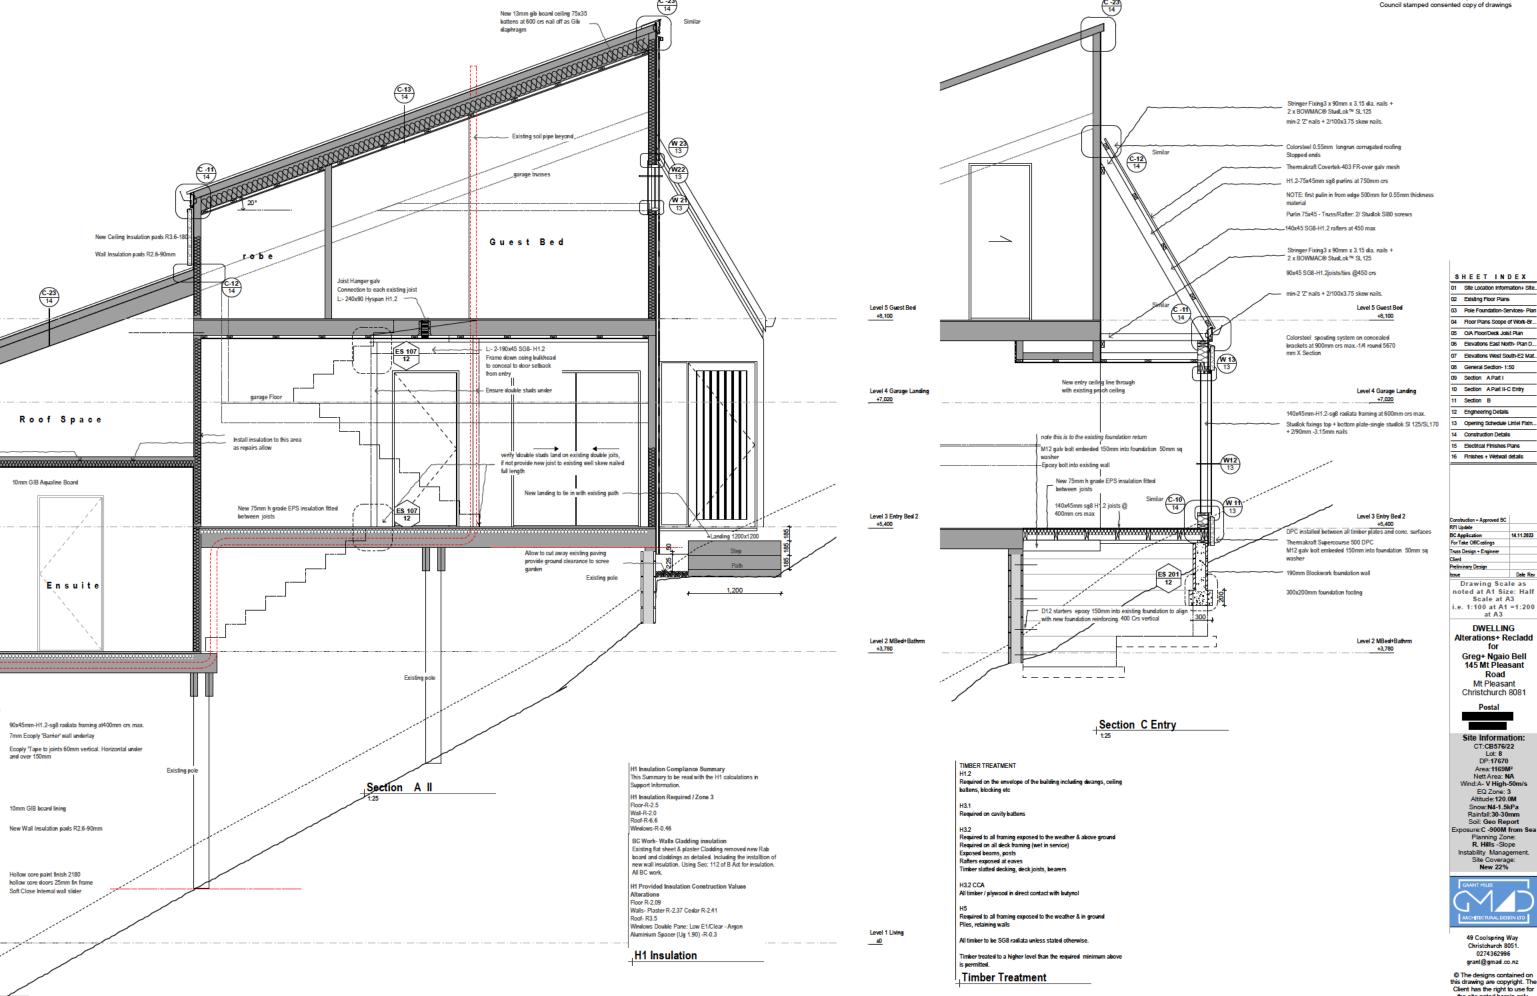


Planning Zone: R. Hills -Slope

49 Coolspring Way Christchurch 8051. 0274362996

grant@gmad.co.nz

Sheet No.

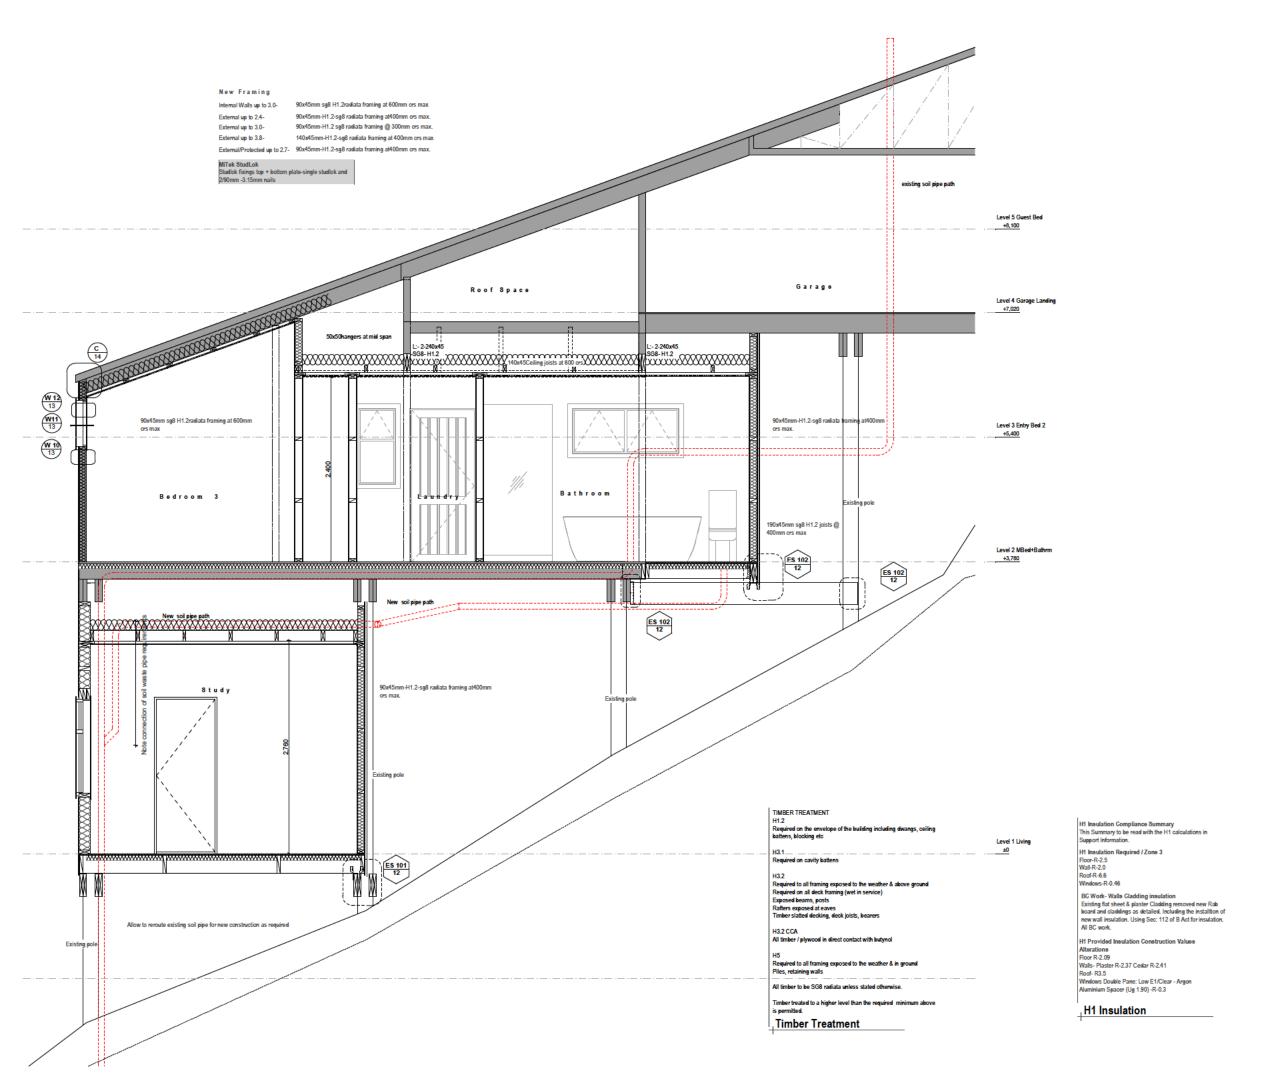

All drawings released prior to building consent being issued are deemed preliminary & subject to change without notice. Work shall only commence with a Council stamped consented copy of drawings

SHEET INDEX 01 Site Location Information+ Site. 02 Existing Floor Plans 03 Pole Foundation-Services- Plan 04 Floor Plans Scope of Work-Br...

05 O/A Floor/Deck Joist Plan 06 Elevations East North- Plan D...

07 Elevations West South-E2 Mat.

08 General Section- 1:50 09 Section A Part I

10 Section A Part II-C Entry

11 Section B

12 Engineering Details

13 Opening Schedule Lintel Fixin... 14 Construction Details

15 Electrical Finishes Plans

16 Finishes + Wetwali details

Construction + Approved BC
RR Update
BC Application 14.11.2023
For Take Officedings
Tress Design - Engineer
Client
Determinary Design
Stose
Date Rev
Drawling Scale as
noted at A1 Size: Half
Scale at A3
i.e. 1:100 at A1 =1:200
at A3

DWELLING Alterations+ Recladd for Greg+ Ngaio Bell 145 Mt Pleasant

Road Mt Pleasant Christchurch 8081

Postal

Site Information:
CT:CB576/22
Lot: 8
DP:17670
Area:1169M*
Nett Area: NA
Wind:A-V High-50m/s
EQ Zone: 3
Altitude:120.0M
Snow:N4-1.5RPa
Rainfall:30-30mm
Soil: Geo Report
sosure:C -900M from Sea
Planning Zone: Planning Zone: R. Hills -Slope Instability Management. Site Coverage: New 22%





49 Coolspring Way Christchurch 8051. 0274362996 grant@gmad.co.nz


© The designs contained on this drawing are copyright. The Client has the right to use for the site noted herein only.

Date Sheet No.
BC 14/11/2023 11
Job Ref. or 16


Section B Rev

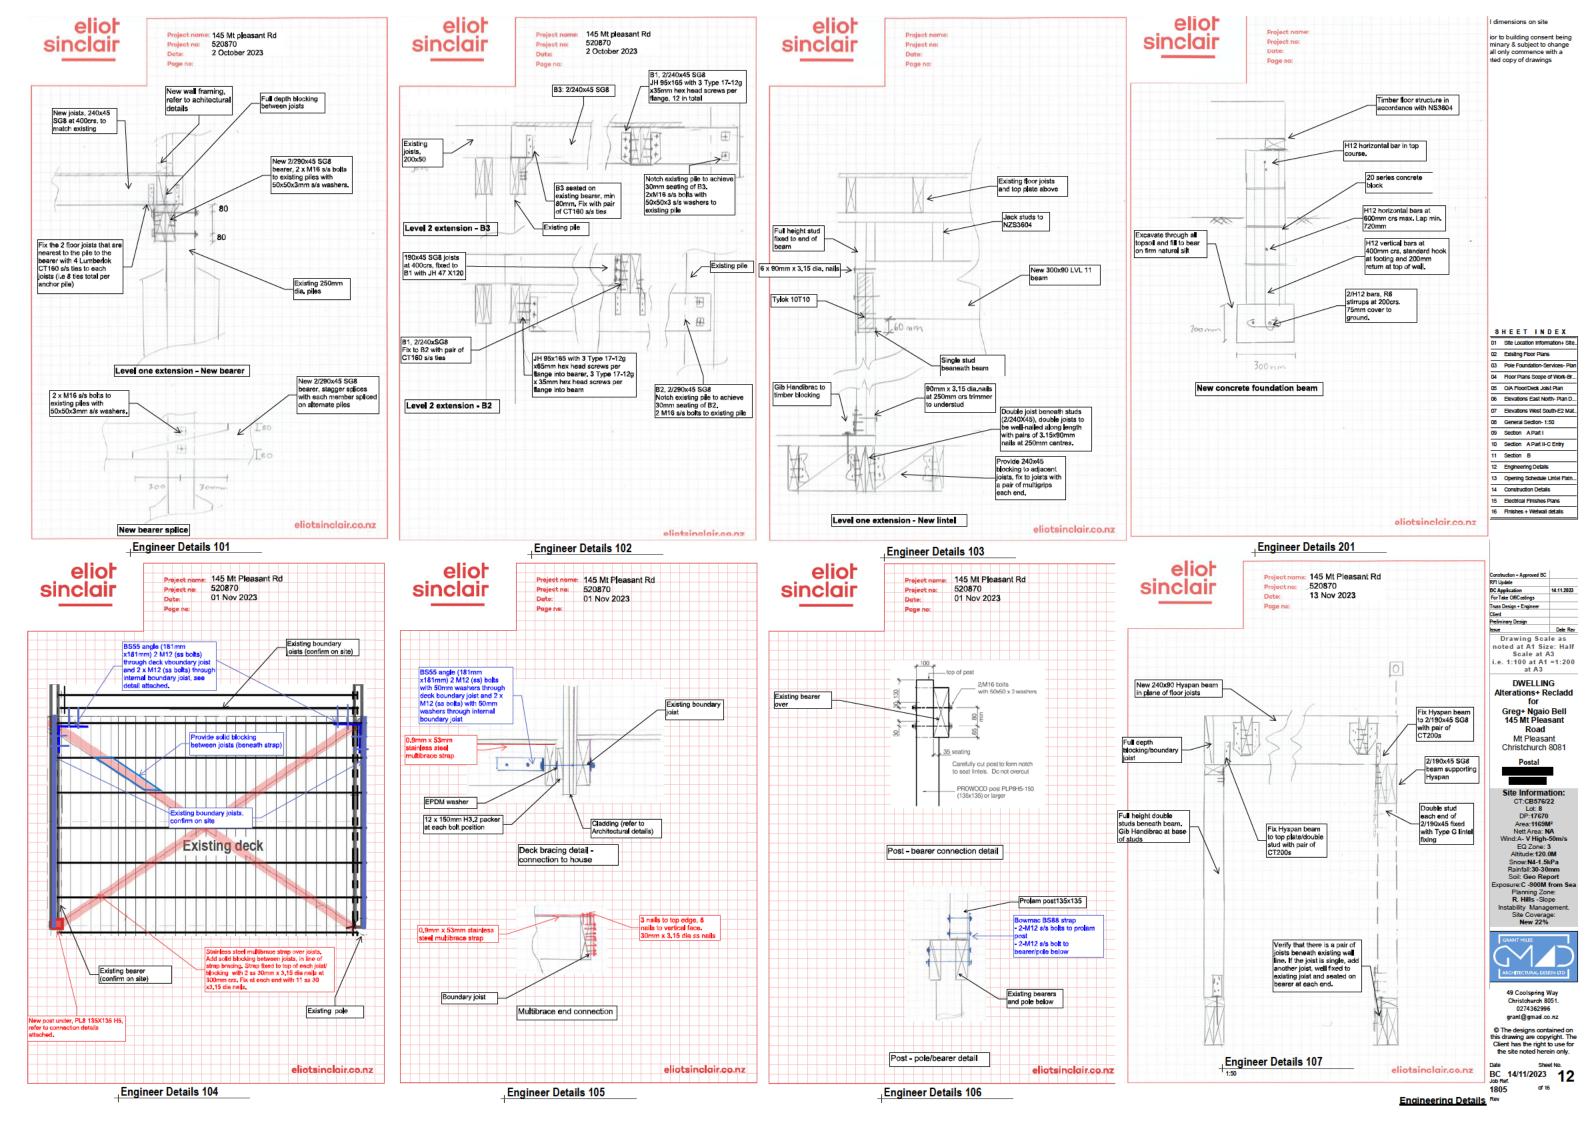


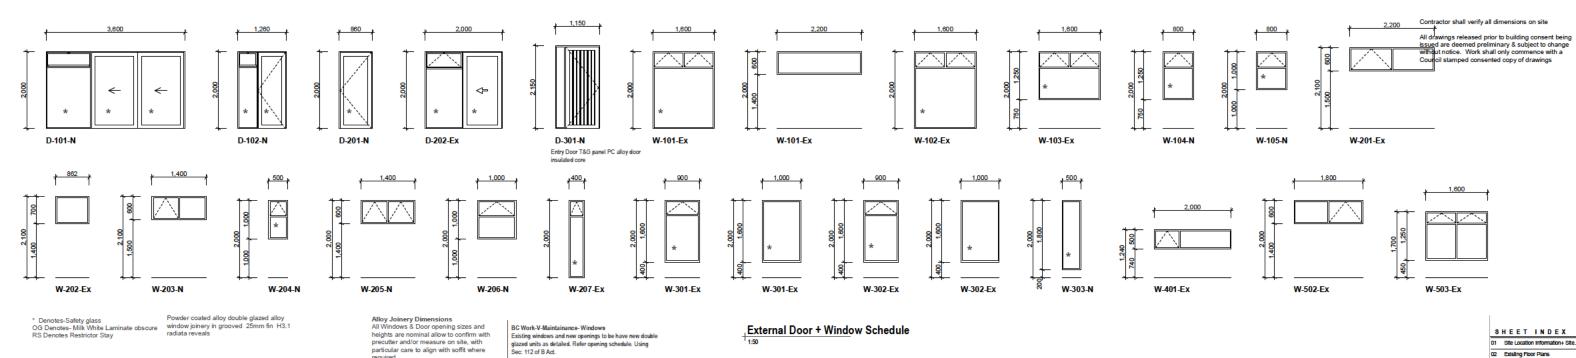

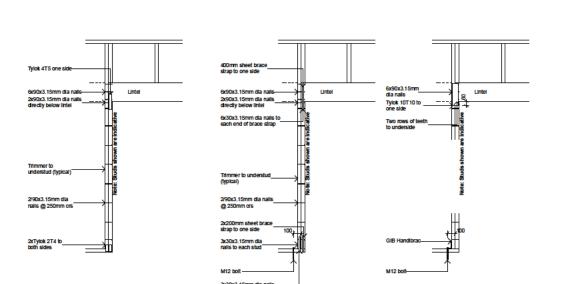



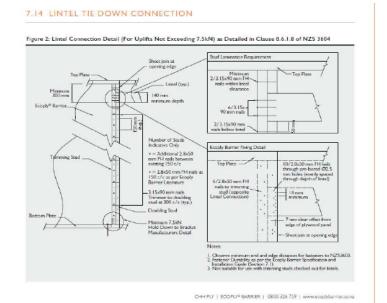

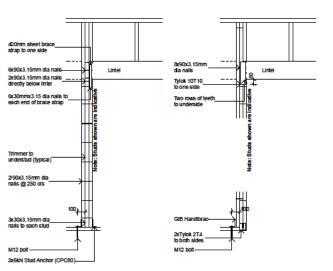


TYPE H - 13.5kN fixing options

TYPE G - 7.5kN fixing options

Eco Ply Barrier Alternative

Up to 7.5 kN fixing and openings up to 2.400 wide based on loaded dimension of 3.000 and V high wide zone $\,$

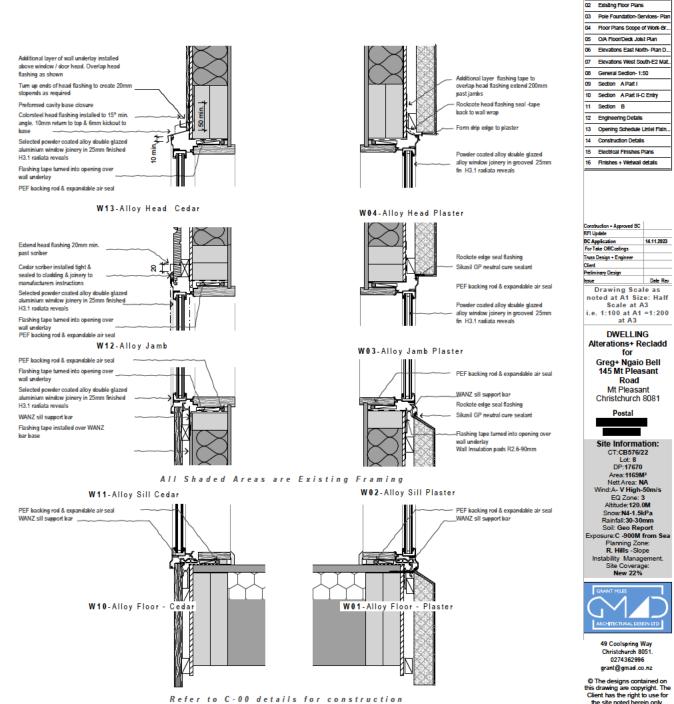

DWFI LING Alterations+ Recladd for


Greg+ Ngaio Bell 145 Mt Pleasant

Date Rev

Planning Zone: R. Hills -Slope Instability Managem Site Coverage: New 22%

49 Coolspring Way Christchurch 8051. 0274362996 grant@gmad.co.nz

Sheet No. BC 14/11/2023 13 1805 of 16

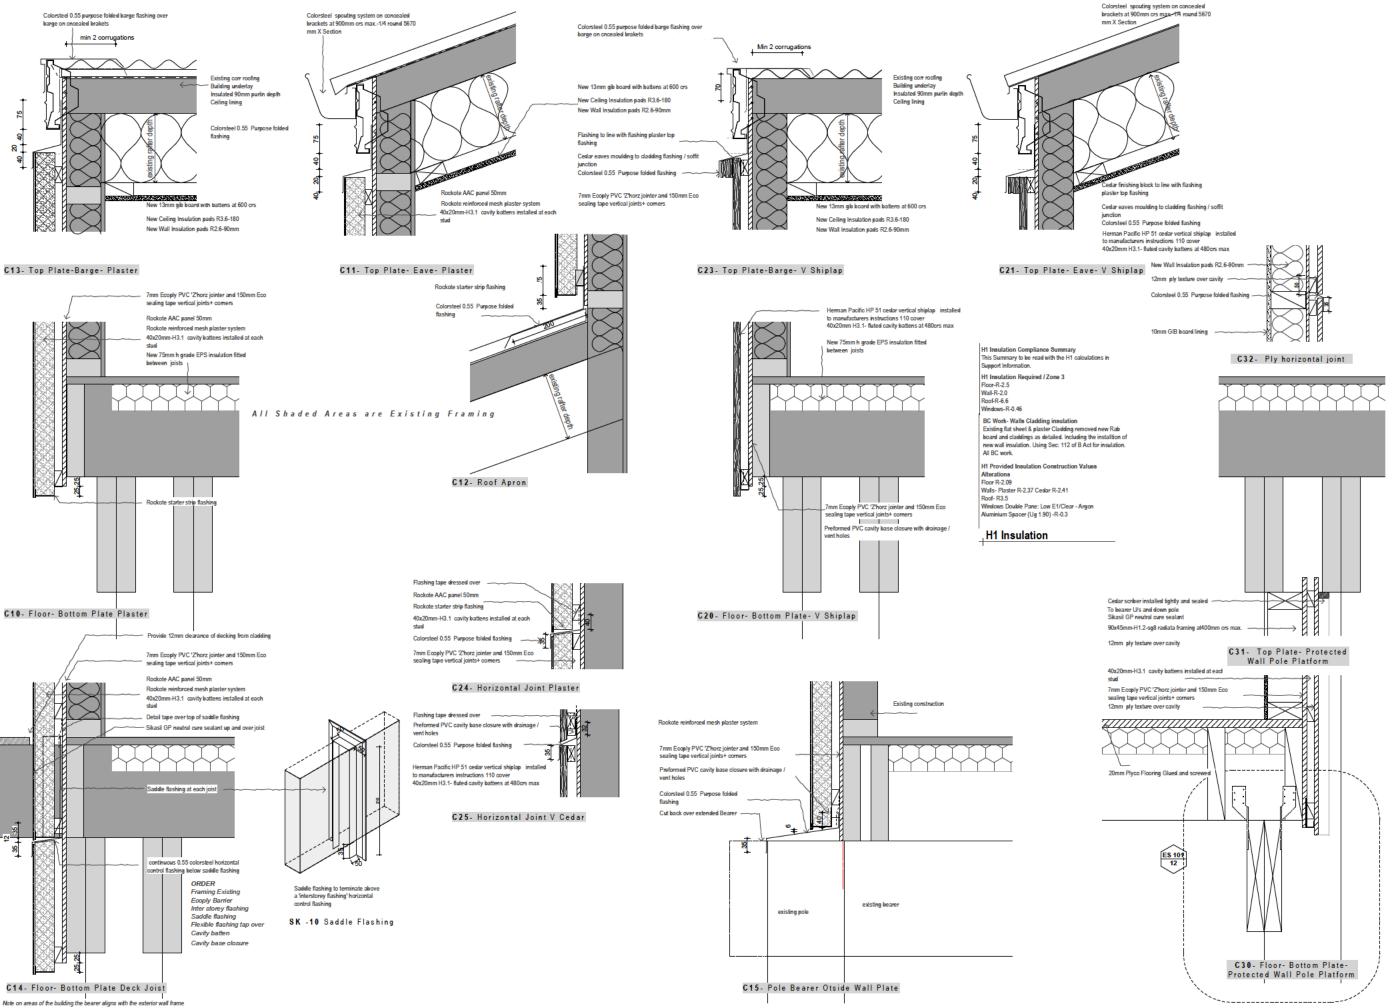

05 O/A Floor/Deck Joist Plan 06 Elevations East North- Plan D... 07 Elevations West South-E2 Mat. 08 General Section- 1:50 09 Section A Part I 10 Section A Part II-C Entry 11 Section B 12 Engineering Details 13 Opening Schedule Lintel Fixin... 14 Construction Details 15 Electrical Finishes Plans 16 Finishes + Wetwall details BC Application For Take Off/Costings 14.11.2023 Truss Design + Engineer
Client
Preliminary Design Date Rev Drawing Scale as noted at A1 Size: Half Scale at A3 i.e. 1:100 at A1 =1:200 at A3

SHEET INDEX

01 Site Location Information+ Site.

03 Pole Foundation-Services- Pla

04 Floor Plans Scope of Work-Br.

02 Existing Floor Plans

Alterations+ Recladd for Greg+ Ngaio Bell 145 Mt Pleasant Road Mt Pleasant Christchurch 8081

DWFLLING

Postal


Site Information:
CT:CB576/22
Lot: 8
DP:17670
Area:T169M*
Nett Area: NA
Wind:A-V High-50m/s
EQ Zone: 3
Altitude:120.0M
Snow:NA-1.5kPa
Rainfail:30-30mm
Soit: Geo Report
Exposure:C-900M from Sea
Planning Zone:
R. Hills -Slope
Instability Management.
Site Coverage:
New 22%



49 Coolspring Way Christchurch 8051. 0274362996 grant@gmad.co.nz

© The designs contained on this drawing are copyright. The Client has the right to use for the site peted beggin each

Date Sheet No.
BC 14/11/2023 14
1805 of 16

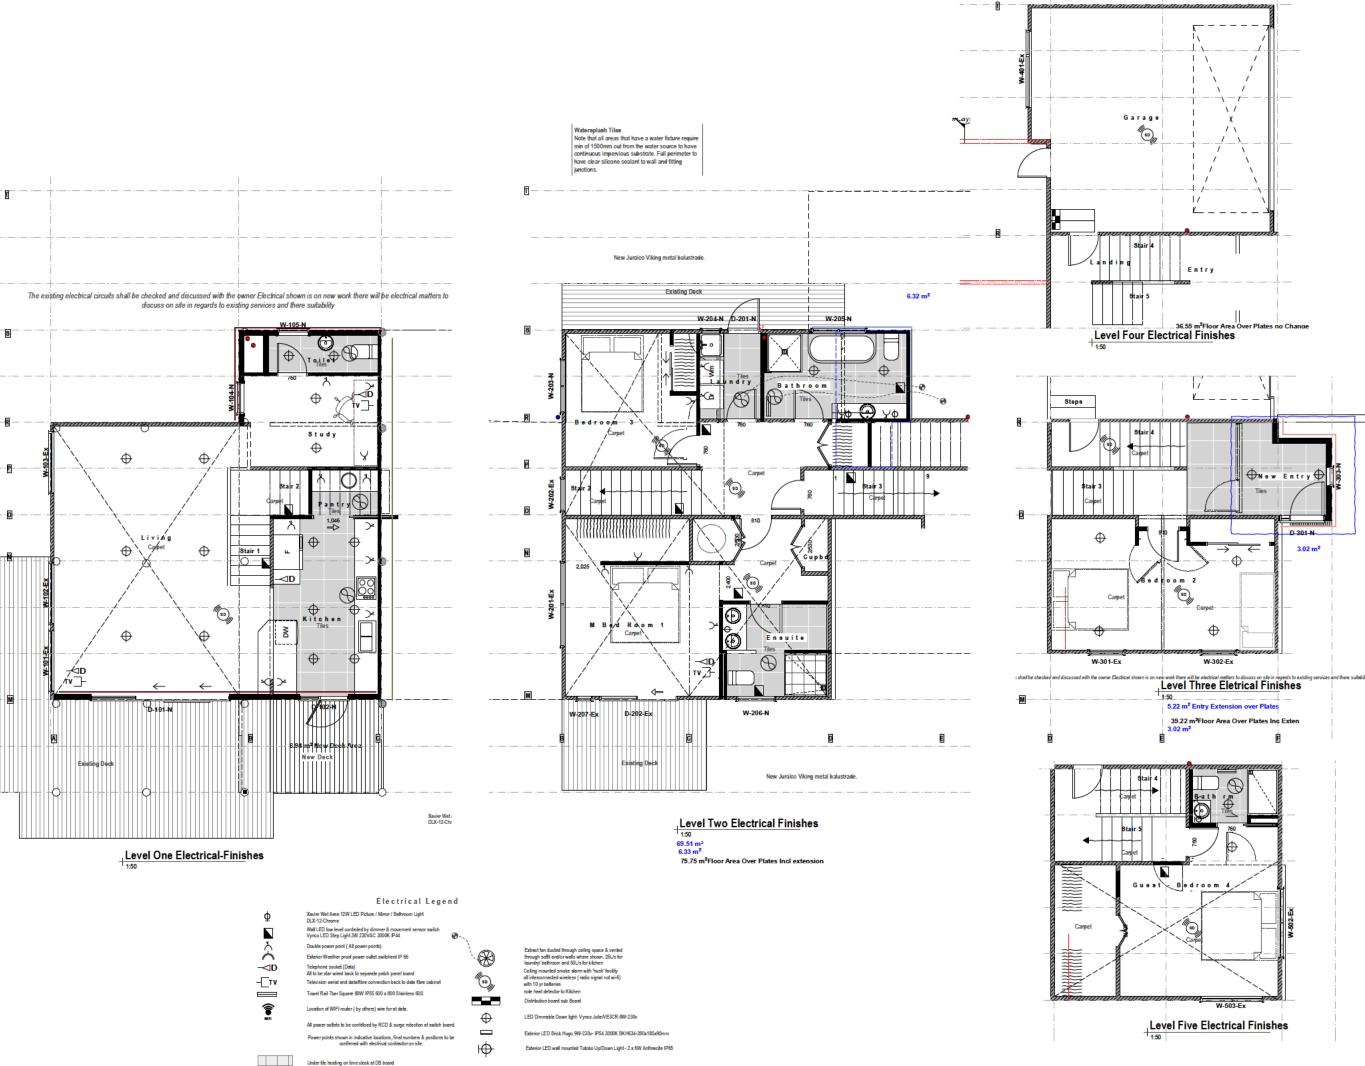

All drawings released prior to building consent being issued are deemed preliminary & subject to change without notice. Work shall only commence with a Council stamped consented copy of drawings

02 Existing Floor Plans 03 Pole Foundation-Services- Plan 04 Floor Plans Scope of Work-Br. 05 O/A Floor/Deck Joist Plan 06 Elevations East North- Plan D... 07 Elevations West South-E2 Mat. 08 General Section- 1:50 09 Section A Part I 10 Section A Part II-C Entry 11 Section B 12 Engineering Details 13 Opening Schedule Lintel Fixin... 14 Construction Details 15 Electrical Finishes Plans 16 Finishes + Wetwall details

SHEET INDEX

01 Site Location Information+ Site.

Alterations+ Recladd for Greg+ Ngaio Bell 145 Mt Pleasant Road Mt Pleasant Christchurch 8081

For Take Off Costings
Truss Design - Engineer
Citet
Pelminsey Design
Sasue
Drawing Scale as
noted at A1 Size: Half
Scale at A3
i.e. 1:100 at A1 =1:200
at A3

DWFI LING

14.11.2023


Postal


Site Information:
CT:CB576/22
Lot: 8
DP:17670
Area:1169M*
Nett Area: NA
Wind:A-V High-50m/s
EQ Zone: 3
Altitude:120.0M
Snow:N4-1.5kPa
Rainfall:30-30mm
Soil: Geo Report
osure:C -900M from Sea
Flanning Zone: Planning Zone: R. Hills -Slope Instability Management. Site Coverage: New 22%



49 Coolspring Way Christchurch 8051. 0274362996 grant@gmad.co.nz

Date Sheet No.
BC 14/11/2023 15
Job Ref. or 16

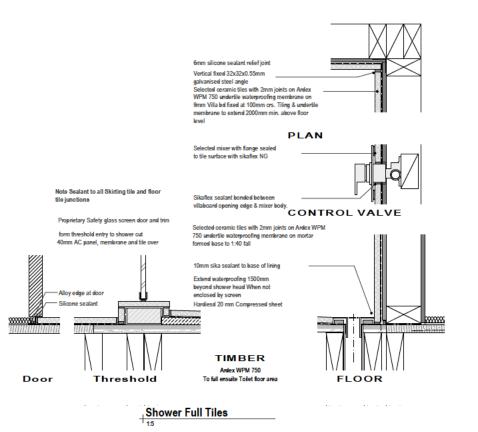

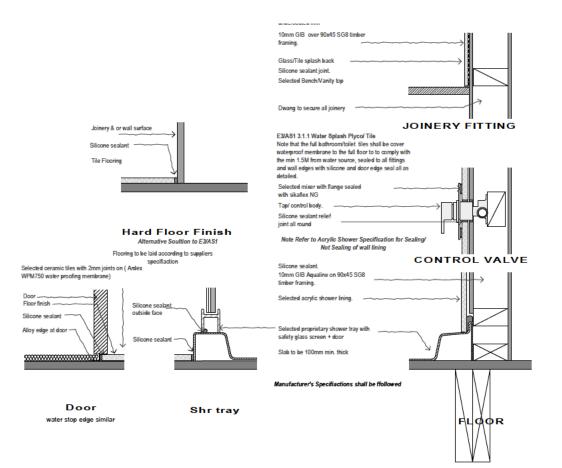

Finishes Schedule General erv in 25mm finished H3.1 radiata reveals xternal Joinery: New eveals to be painted) Tiled Floors: New in tiles with 2mm joints on metal float finished concrete floor Ardey WPM 002 water neo-Refer Watersplash note Plyco Floors/ Stair: arage Floor: temal Walls: New Resene water based acrylic on 10mm Gib lining (level 4 finish) to all walls unless noted otherwise mal Walls New(Wet Resene Semi gloss water based enamel on 10mm Gib bd (level 4 finish) Areas): al Ceilings: New Resene water based acrylic on 13mm (General) Gib bd (level 4 finish) to all ceilings unle ernal Ceilings: New(Wet Areas) Semi gloss water based enamel on 13mm Gib Bd (level 4 finish) lote Existing surfaces to have Resene quickdry undercoat and finished as above. emal Doors: New MDF with 25mm Finished grooved radiata reveals (reveals & door to be painted semi gloss) 2000 high Unless noted otherwise. nternal Skirting: New MDF & painted semi gloss Cbd / Robe Doora Stiding: Powder coated alloy framed sliders 2200 high with GIB inserts Cbd / Robe Doors Hinged: As standard Internal doors above. Confirm all colours & finishes with client prior to commencement of work


ectrical) Benchtops: Laminex Caesarstone Sink: Under mount stainless steel sink Joinery: Low pressure laminate to all kitchen doors / cuplocards / shelves. Drawers: Steel powder coated wheeled runners with soft closers Cupboards: Overlay hinges spring loaded + soft closers plashback: Glass splashback. Client Selected Hobs: Client selected electric Extract Hood: Selected extract Oven: Client selected under bench over Fridge:Client selected freestanding fridge / freeze hwasher: Client selected dishwasher Laundry Fittings Schedule chtop: Laminex Caesarstone loinery: Low pressure laminate to cupboards / shelves Drawers: Steel powder coated wheeled runners with soft closers pboards: Overlay hinges Spring loaded + soft closers ashback: Glass splashback. Client Selected Tub: Over mount stainless steel tub with mixer Washing machine valves separate - Selected washing machin - Selected clothes dryer Bathroom Fittings Schedule All fittings to be sealed to wall and/or floor with Sikaflex Sealant Shower: Acrylic shower over 10mm Gib Aqualine Safety glass screens WC: Selected ceramic shrouded WC pan & cistem back to wall-S Traps Vanity: 550mm wide ceramic basin on bench joinery unit with storage drawers below Client Selected Toilet Fittings WC: Selected ceramic shrouded WC pan & cistem back to wall-S Traps Basin:Wall hung hand basin All fittings to be sealed to wall with Sikaflex sealant Allow to fit and fix all hardware associated with joinery and Bathroom, ensuite. oilet, laundry and kitchen areas, in door stops, towel rails, toilet roll holders. Ensuite All fittings to be sealed to wall and/or floor with Sikaflex Sealant Shower: TILED shower over 9mm Villa Bd Safety glass screens. WC: Selected ceramic shrouded WC pan & cistem back to wall- S Traps Vanity: Ceramic basin on 1200mm wide bench joinery unit with storage drawer below Client Selected WC: Selected ceramic shrouded WC pan & cistem back to wall-S Traps All fittings to be sealed to wall with Sikaflex sealant llow to fit and fix all hardware associated with joinery and Bathroom, ensuite, toilet, areas, in door stops, towel rails, toilet roll holders.

Kitchen + Pantry+ Bathroom Finishes Schedule

(Allow to fit all fittings and those supplied by Client, including any wet services a

Refer to elevations for external cladding types



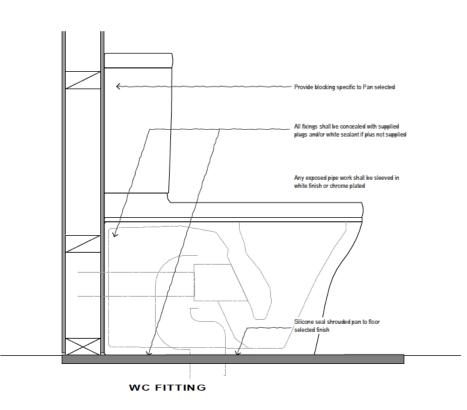

Contractor shall verify all dimensions on site

All drawings released prior to building consent being issued are deemed preliminary & subject to change without notice. Work shall only commence with a Council stamped consented copy of drawings

01 Site Location Information+ Site. 02 Existing Floor Plans 03 Pole Foundation-Services- Plan 04 Floor Plans Scope of Work-Br. 05 O/A Floor/Deck Joist Plan

SHEET INDEX

06 Elevations East North- Plan D... 07 Elevations West South-E2 Mat. 08 General Section- 1:50

09 Section A Part I 10 Section A Part II-C Entry

11 Section B 12 Engineering Details

13 Opening Schedule Lintel Fixin... 14 Construction Details 15 Electrical Finishes Plans

16 Finishes + Wetwall details

BC Application For Take OffCostings 14.11.2023

For Take Officosings
Tinas Design + Engineer
Clent
Prefining Design
Insue
Date Rev
Drawing Scale as
noted at A1 Size: Half
Scale at A3 i.e. 1:100 at A1 =1:200 at A3

DWFI LING Alterations+ Recladd Greg+ Ngaio Bell 145 Mt Pleasant

Road Mt Pleasant Christchurch 8081

Postal

Site Information:
CT:CB576/22
Lot: 8
DP:17670
Area:1169M*
Nett Area: NA
Wind:A- V High-50m/s
EQ Zone: 3
Altitude:120.0M
Snow:N4-1.5kPa
Rainfall:30-30mm
Soil: Geo Report
iosure: C -900M from Sea
Planning Zone: Planning Zone: R. Hills -Slope Instability Management Site Coverage: New 22%



49 Coolspring Way Christchurch 8051. 0274362996 grant@gmad.co.nz

© The designs contained on this drawing are copyright. The Client has the right to use for the site noted herein only.

Sheet No. BC 14/11/2023 16 1805 of 16

Finishes + Wetwall details Rev