


27/07/2023

Lough, Kelsey

Knights Stream

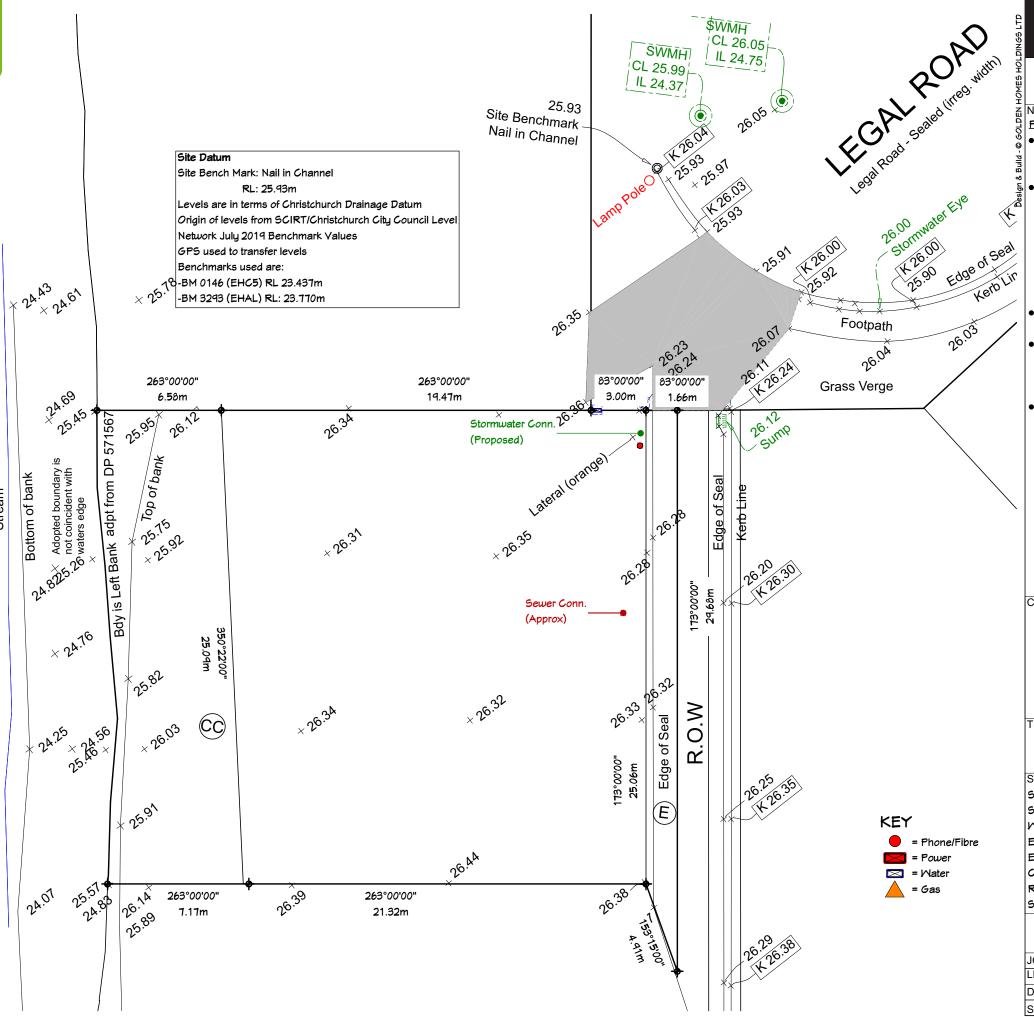




NOTES:

Prior to starting any works

- Locate and identify boundary pegs, service connection points and there inverts (Confirm all falls shown in drawings will comply)
- Public protection from onsite hazards, Site safety fencing (when required by T.A), 2.0m(min) to prevent site hazards from harming traffic or passers-by, to restrict unauthorized entry by children - ensure fencing is difficult to be climbed, gates and doors do not project beyond site when open, and encloses the whole site.
- All building sites to have Worksafe NZ compliant warning signs erected.
- Any hazardous equipment or materials will be stored onsite only if secured, by portable building lock up or in the house being built (after lock-up stage)
- Sites to be assessed on a individual basis by construction managers for compliance with NZBC clause F5 and if specific hazards exist then a work-site barrier must be erected.

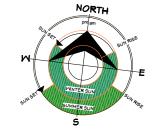

Kosir Residence Lot 14, DP 571567 Kahurangi Road, Knights Stream

Halswell, Canterbury TERRITORIAL AUTHORITY:

Christchurch City Council Residential Suburban Zone

SITE DATA (for zones upto & including):

Sub-soil Classification: E

Soil Classification REF GEO - TC2

Wind Zone: High Earthquake Zone: 2

Exposure Zone:


Climate Zone:

Rain Intensity (10%AEP): 53.7mm/hr

1.0kPa

Site Existing

JOB No: 978	15	SALES:	S <i>o</i> nja
LBP: C.Me	arne 1011	78	
DRAWN:	Katherine	DATE:	25/10/2022
SCALE:	1:200	SHEET No.	2 OF 55

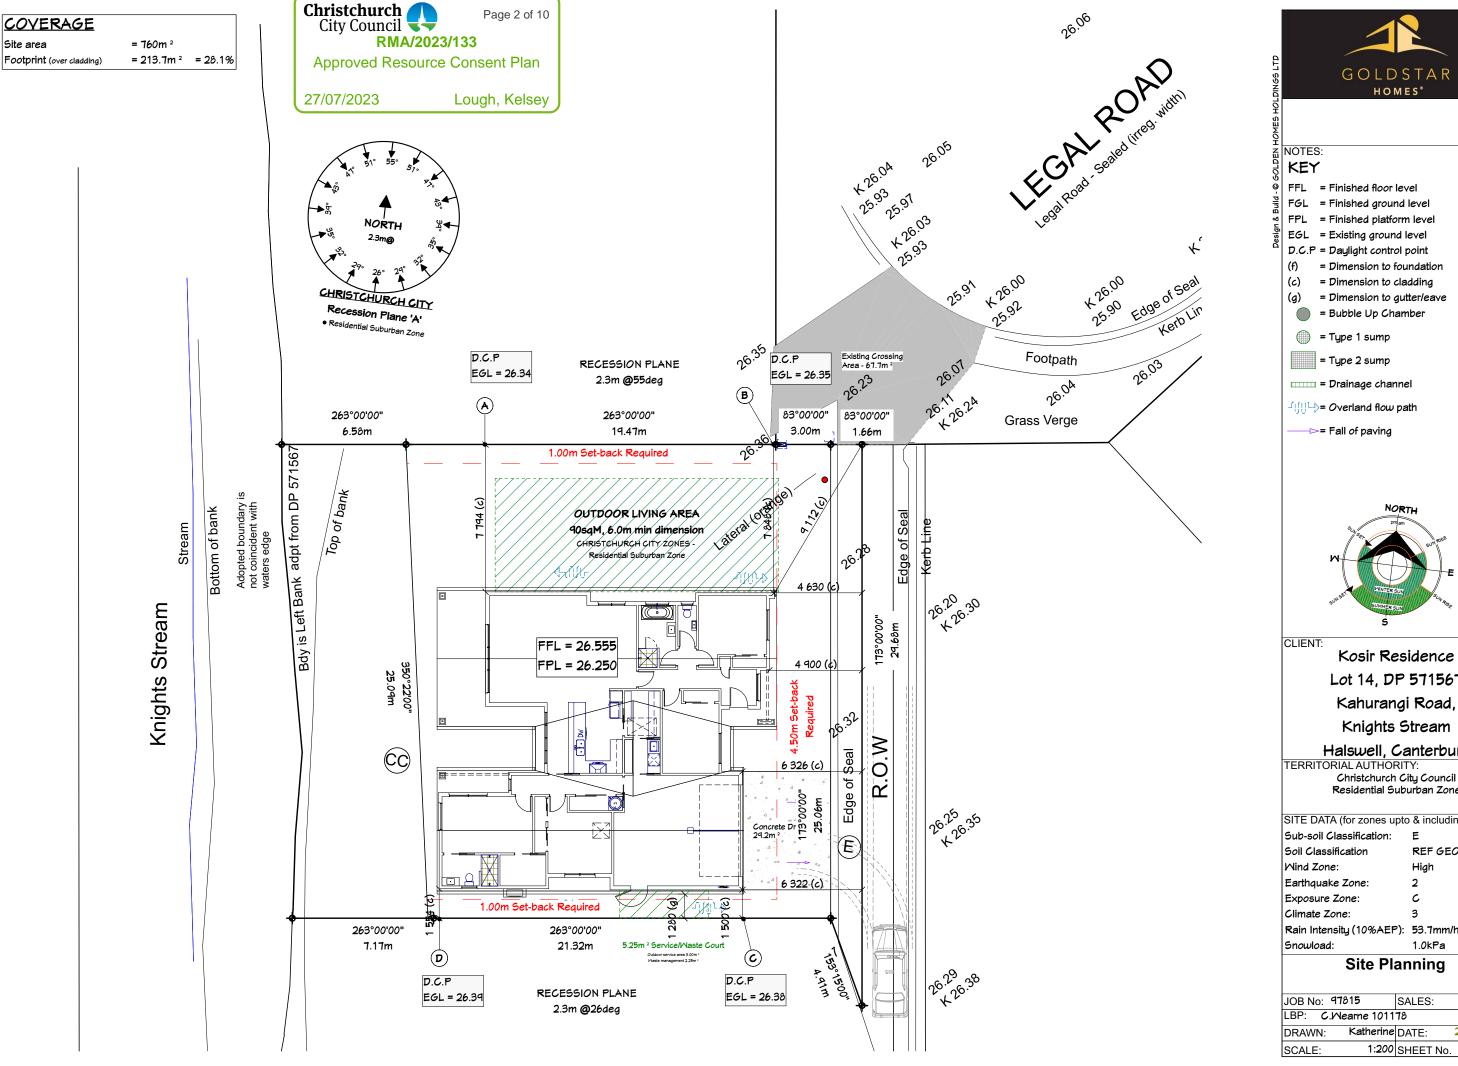




= Finished ground level

= Finished platform level

= Dimension to cladding

= Dimension to gutter/eave

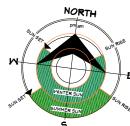

Kosir Residence Lot 14, DP 571567 Kahurangi Road, Knights Stream

Halswell, Canterbury

Residential Suburban Zone

SITE DATA (for zones upto & including):

REF GEO - TC2

High

2

C

Rain Intensity (10%AEP): 53.7mm/hr

1.0kPa

Site Planning

JOB No: 97	1815	SALES:	Sonja
LBP: C.M	learne 1011	78	
DRAWN:	Katherine	DATE:	25/10/2022
SCALE:	1:200	SHEET No.	3 OF 55



NOTES: 83°00'00" 83°00'00" 263°00'00" 263°00'00" 3.00m 6.58m 19.47m 1.66m Bdy is Left Bank adpt from DP 571567 Top of bank Adopted boundary is not coincident with waters edge Bottom of bank Stream 4 630 (c) Knights Stream 173°00'00" 24.68m 4 900 (4) Refer to Cladding Details page for >.0 (CC) 6 326 (c) α SP 001 E 6 322 (c) <u>@</u> 263°00'00" 263°00'00" 7.17m 21.32m Halswell, Canterbury
TERRITORIAL AUTHORITY:
Christchurch City Council
Residential Suburban Zone SITE DATA (for zones upto & including): Sub-soil Classification: E Soil Classification Mind Zone: Earthquake Zone:

GOLDSTAR HOMES®

Finished Ground Reference

Std Raft Slab

Kosir Residence

Lot 14, DP 571567 Kahurangi Road,

Knights Stream

REF GEO - TC2

Sonja

High

1.0kPa

1:200 SHEET No. 6 OF 55

2

C

SALES:

Rain Intensity (10%AEP): 53.7mm/hr

JOB No: 97815 | SAI LBP: C.Wearne 101178

Site Plan

Katherine DATE:

Exposure Zone:


Climate Zone:

DRAWN:

50mm AAC Panels on

a drained cavity

27/07/2023 Lough, Kelsey

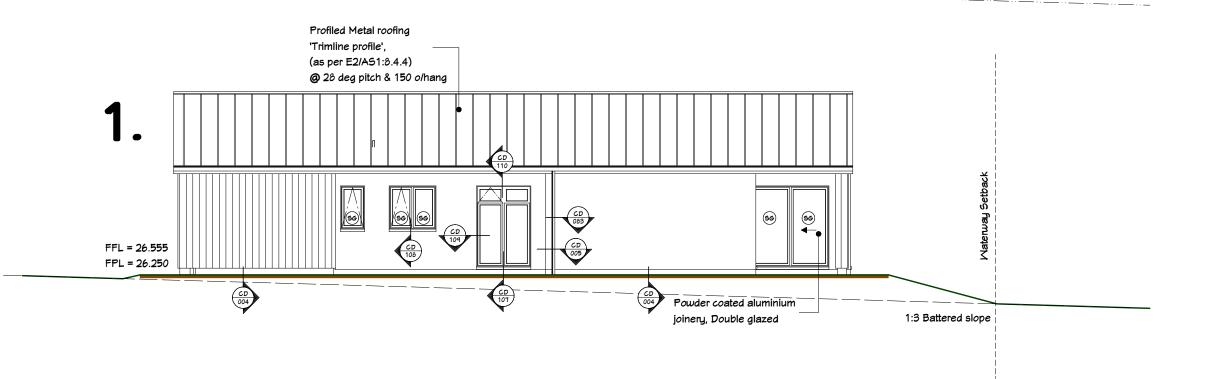

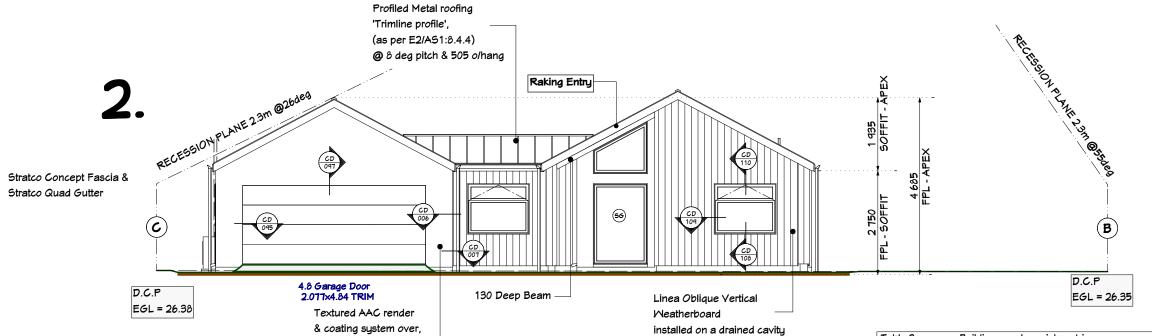


Table 2 Building en	Building envelope risk matrix					
Paragraph 3.1.2. Figure 1						
All Malls Ris	All Walls Risk Severity					
Risk factor		Med	High	Very	Subtotals for	
				High	each risk factor	
Wind zone (per NZS 3604)		0	1	2	1	
Number of storeus		1	2	4	0	
Roof/wall intersection design		1	3	5	3	
Eaves width		1	2	5	2	
Envelope complexity		1	3	6	1	
Deck Design	0	2	4	6	0	
Total Risk Score 7					7	



NOTES:


• If windows & doors are shown upto soffit, window and door sizes are to be measured on site prior to the manufacture of those units.

FFL = Finished Floor Level

FGL = Finished Ground Level

FPL = Finished Platform Level

EGL = Existing Ground Level

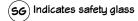

Safety Glazing

- All glazing is to be in accordance with the NZ Building Code Handbook and NZS.4223, Parts 1, 2, & 3 Code of Practice for Glazing in Buildinas.
- All glazing panels to bathrooms and toilets to have safety glazing to the interior panel only
- All gazing to be confirmed by the manufacturer prior to construction

Callout of Details



= Reference to Cladding Details CD###

CLIENT:

Kosir Residence Lot 14, DP 571567 Kahurangi Road, Knights Stream

Halswell, Canterbury TERRITORIAL AUTHORITY:

Christchurch City Council Residential Suburban Zone

SITE DATA (for zones upto & including):

Sub-soil Classification: E

Soil Classification REF GEO - TC2 Wind Zone: High

Earthquake Zone:

2 Exposure Zone:

Climate Zone:


Rain Intensity (10%AEP): 53.7mm/hr 1.0kPa

Elevations .1

JOB No: 91	פוס	SALES:	Sonja
BP: C.M	earne 1011		
DRAWN:	Katherine	DATE:	25/10/2022
SCALE:	1:100	SHEET NO	10 OF 55

27/07/2023

Lough, Kelsey

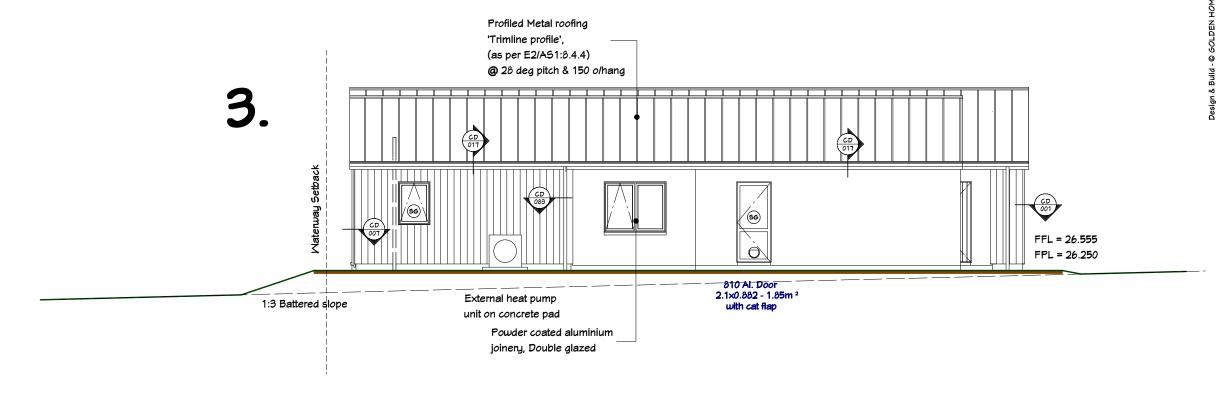

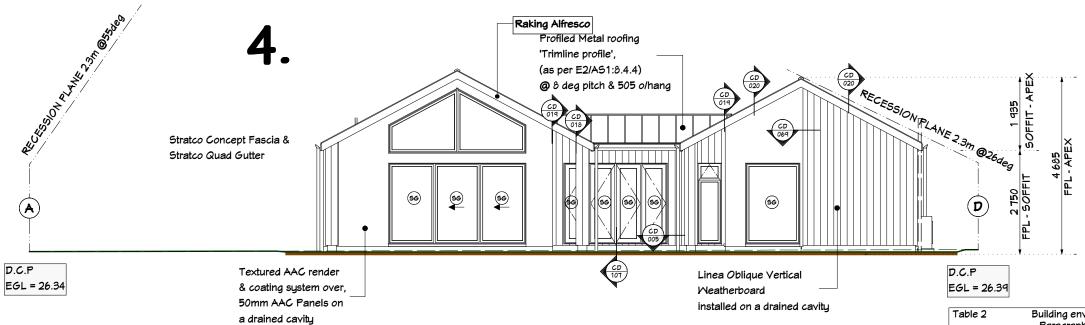


Table 2 Building envelope risk matrix							
Paragraph 3.1.2. Figure 1							
All Malls Risk	All Malls Risk Severity						
Risk factor	Low	Med	High	Very	Subtotals for		
				High	each risk factor		
Inlied comp (non-bl76 3604)	^		1	2	1		
Wind zone (per NZS 3604)	0	0	\vdash	2			
Number of storeus	0	1	2	4	0		
Roof/wall intersection design	0	1	3	5	3		
Eaves width	0	1	2	5	2		
Envelope complexity	0	1	3	6	1		
Deck Design	0	2	4	6	0		
Total Risk Score 7							



NOTES:


• If windows & doors are shown upto soffit, window and door sizes are to be measured on site prior to the manufacture of those units.

FFL = Finished Floor Level

FGL = Finished Ground Level

FPL = Finished Platform Level

EGL = Existing Ground Level

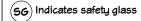

Safetu Glazina

- All glazing is to be in accordance with the NZ Building Code Handbook and NZS.4223, Parts 1, 2, & 3 Code of Practice for Glazing in Buildings.
- All glazing panels to bathrooms and toilets to have safety glazing to the interior panel only
- All gazing to be confirmed by the manufacturer prior to construction

Callout of Details



(### = Reference to Cladding Details CD###

CLIENT:

Kosir Residence Lot 14, DP 571567 Kahurangi Road, Knights Stream

Halswell, Canterbury TERRITORIAL AUTHORITY:

Christchurch City Council Residential Suburban Zone

SITE DATA (for zones upto & including):

Sub-soil Classification: E

Soil Classification REF GEO - TC2 Mind Zone: High

Earthquake Zone: 2 Exposure Zone:

Climate Zone:

Rain Intensity (10%AEP): 53.7mm/hr

Snowload: 1.0kPa

Elevations .2

JOB No: 97	815	SALES:	Sonja
LBP: C.M	earne 1011	78	
DRAWN:	Katherine		25/10/2022
SCALE:	1:100	SHEET No.	11 OF 55




Lough, Kelsey

Tiled shower (Unenclosed)

1. Recess with 1:50 Fall to drain

2. 1500 radius from rose (as shown)

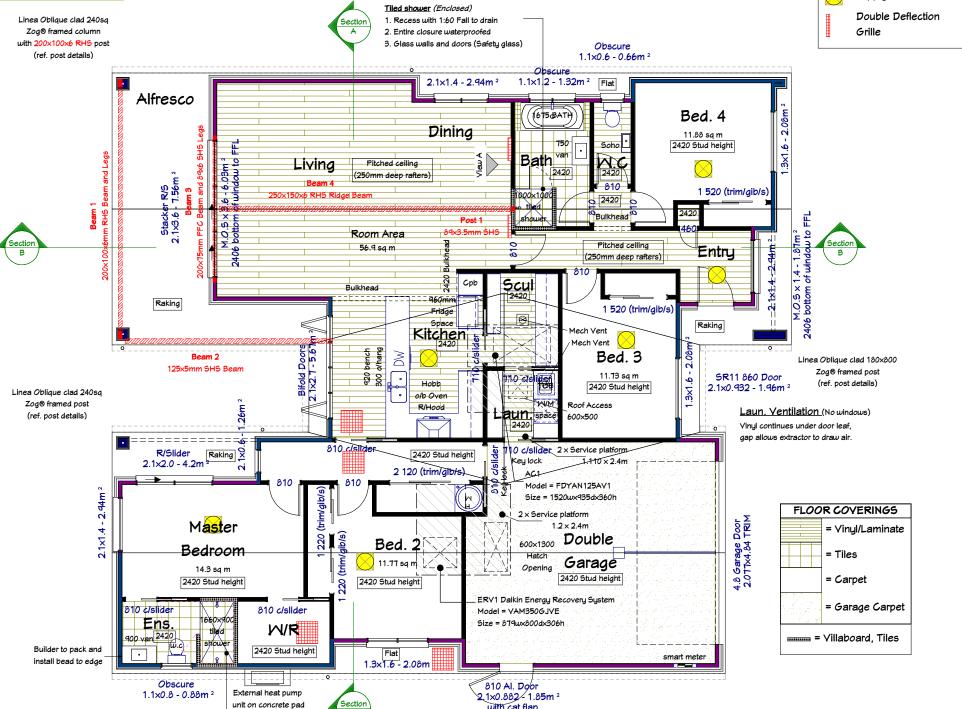

I-/97000 NDM Construction/97815 Kosir/97815 Kosir plan

Heating in Ceiling

Return Grille

Supply Grille

TOTAL FLOOR AREA LIVING AREA GARAGE AREA (excl. Laun)

TOTAL BOOK AREA

TOTAL ROOF AREA

APPROXIMATE Exterior wall perimeter
APPROXIMATE Interior wall perimeter
APPROXIMATE Fascia & Gutter lineal meters

APPROXIMATE Barge lineal meters

Stud height - Refer to plan Interior door height - 1980mm

Truss heel height - 28° 250mm, 8° 239mm

GOLDSTAR HOMES*

NOTES:

89x41mm ZOG® framing

- Natural lighting is provided via glazing to
 10% of floor areas for individual rooms
- Natural ventilation is provided via exterior openings of no less than 5% of floor area for individual rooms
- Internal and external walking surfaces to comply with NZBC D1/AS1 2.1.1 - 2.1.3, and Table 2
- External Access Routes surface is either; brushed concrete, exposed crushed aggregate concrete, profiled timber with the profile across the direction of travel, or be flooring selected by the client with a wet slip coefficient of no less than 0.4, refer to the specification for compliance procedure in such situations
- Where FFL is greater than 1.0m from FGL and the bottom of the opening is closer than 760mm to the FFL or a climbable fixture, a restrictor stay is to be fitted to limit the maximum opening so that a 100mm dia sphere cannot pass through it.
- All access routes are to be protected by dangerous projections as shown in D1/AS1,
 Fig 6

4 2 3 ELEVATION GUIDE

CLIENT:

= 213.7saM

= 173.2saM

= 40.5sqM

= 77.7m

= 83.3m

= 52.2m

= 30.9m

= 256.7saM

Kosir Residence Lot 14, DP 571567 Kahurangi Road, Knights Stream

Halswell, Canterbury

TERRITORIAL AUTHORITY:

Christchurch City Council Residential Suburban Zone

SITE DATA (for zones upto & including):

Sub-soil Classification: E


Soil Classification REF GEO - TC2
Wind Zone: High
Earthquake Zone: 2


Exposure Zone: C
Climate Zone: 3

Rain Intensity (10%AEP): 53.7mm/hr Snowload: 1.0kPa

Floor Plan

JOB No: 97		SALES:	Sonja
LBP: C.M	earne 1011	78	
DRAWN:	Katherine		25/10/2022
SCALE:	1:100	SHEET No.	12 OF 55

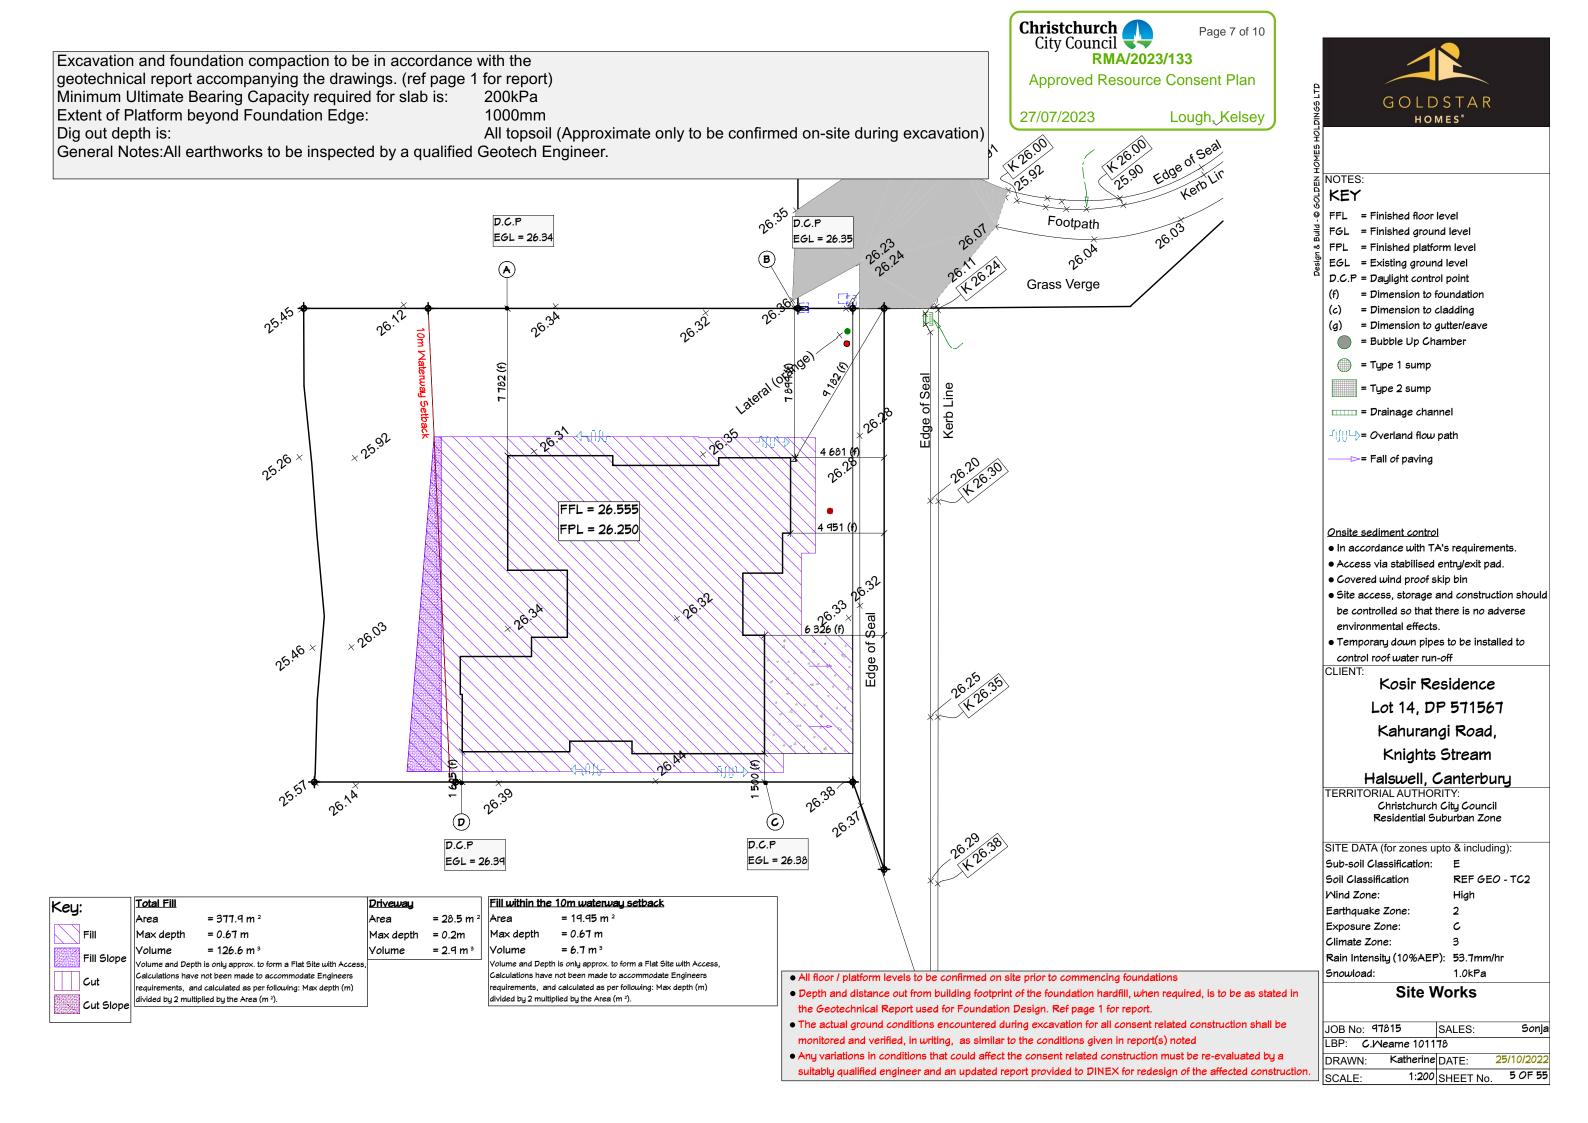

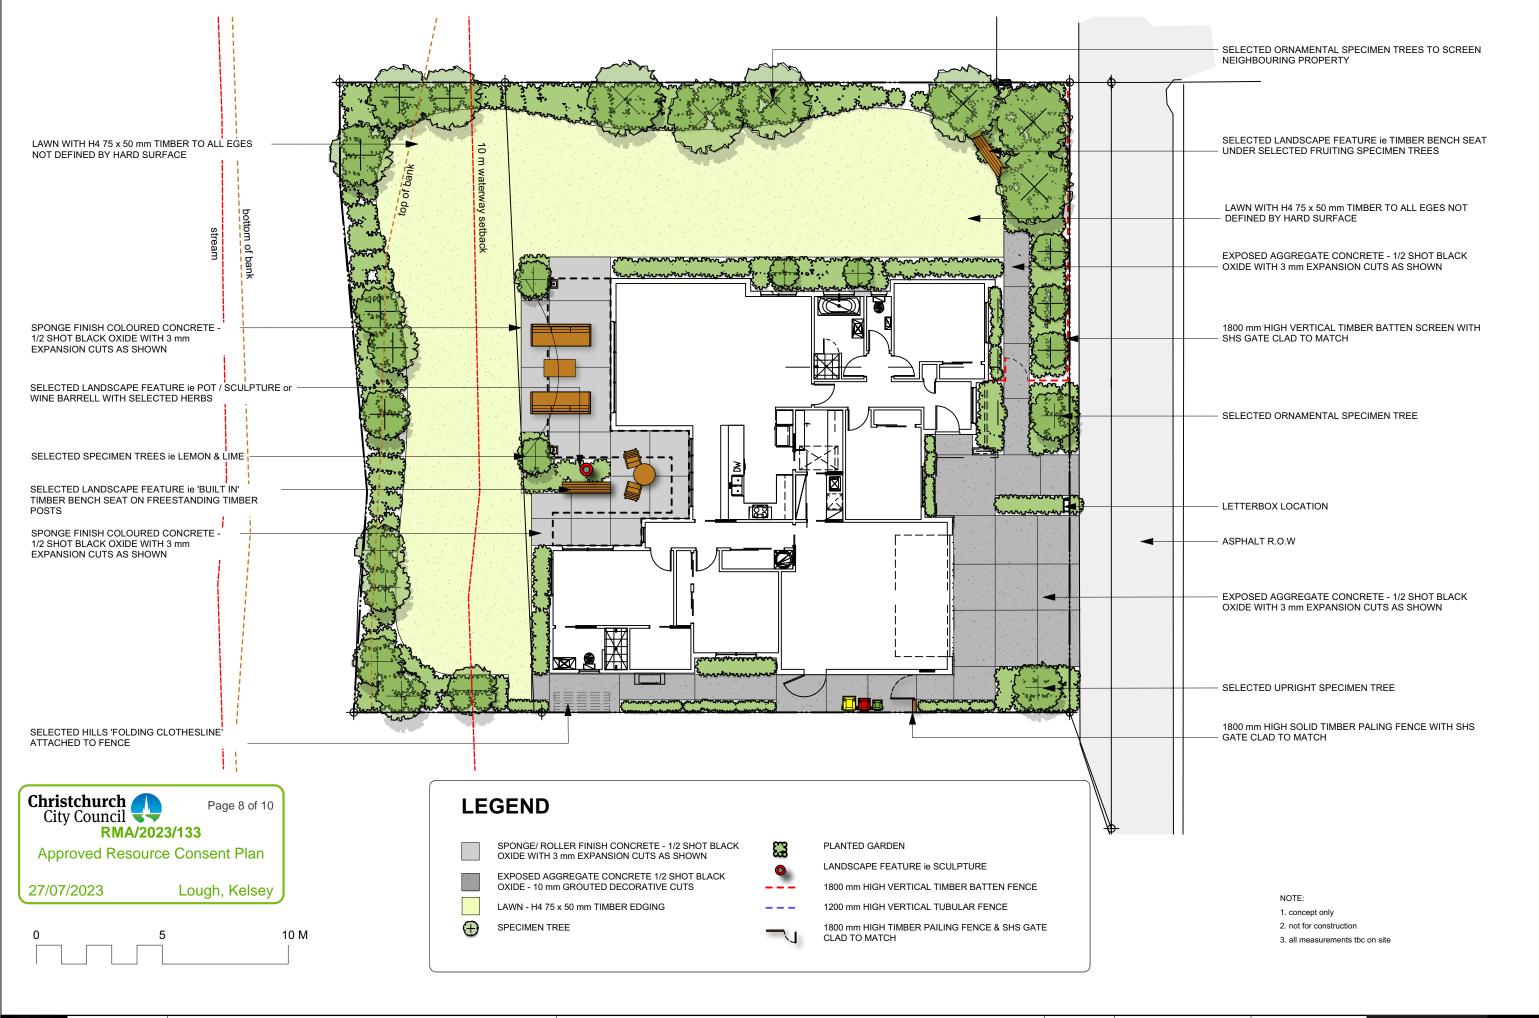






: NKAY

DRAWN

VERIFIER



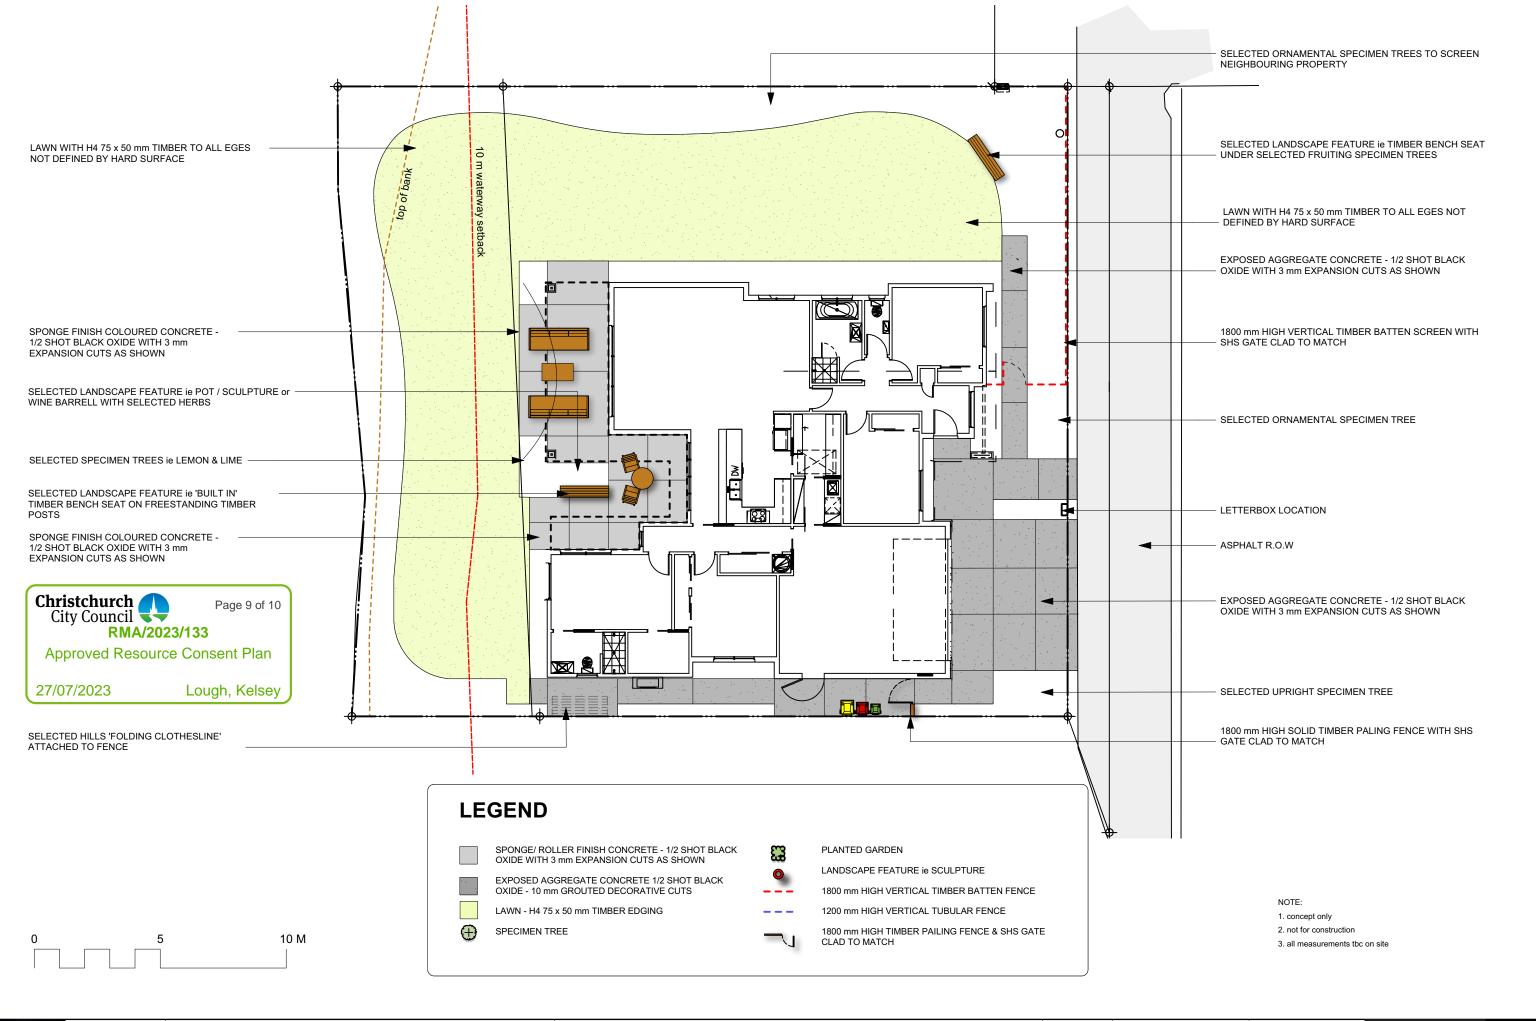



KOSIR RESIDENCE

LOT 14, KAHURANGI ROAD, KNIGHTS STREAM



SCALE : 1:150 @ A3

: NKAY

: NKAY

DRAWN

VERIFIER

DRAWING NUMBER

KOSIR-L-1.1









VERIFIER

: NKAY

KOSIR-L-2.1

