

Site area = 760m²

Footprint (over cladding) = 213.7m² = 28.1%

4500g 75.93 25.97 15003 75.9³ 45000 25.91 Recession Plane 'A' • Residential Suburban Zone JO.35 -D.C.P D.C.P Existing Crossing Area - 67.7m² Footpath 26.07 RECESSION PLANE EGL = 26.34 EGL = 26.35 26.23 26.04 2.3m @55deg 26.176.24 (B) (A)263°00'00" 263°00'00" 83°00'00" 83°00'00" **Grass Verge** 6.58m 19.47m 3.00m 1.00m Set-back Required OUTDOOR LIVING AREA Edge of Seal Kerb Line 90sqM, 6.0m min dimension CHRISTCHURCH CITY ZONES -Residential Suburban Zone 126.76 4 630 (c 173°00'00" 29.68m FFL = 26.555 350°22'00" 25.09m FPL = 26.250 4 900 (¢) 16.32° >.0 Seal (CC) 6 326 (c) Edge of \$ 2 126.25 120.35 E 6 322 (c) D છ 1.00m Set-back Required 263°00'00" 263°00'00" 7.17m 21.32m 5.25m 2 Service/Maste Court \bigcirc ્રં જો **(c)** 126.78.38 A.anm D.C.P D.C.P RECESSION PLANE EGL = 26.39 EGL = 26.38 2.3m @26deg

Adopted boundary is not coincident with waters edge Knights Stream



NOTES:

4

Edge of Seal

KerbLin

45000

50,00

KEY

FFL = Finished floor level

FGL = Finished ground level

= Finished platform level

= Existing ground level

D.C.P = Daylight control point

= Dimension to foundation

= Dimension to cladding

= Dimension to gutter/eave

= Bubble Up Chamber


= Type 1 sump

= Type 2 sump

= Drainage channel

∬∭->= Overland flow path

—⇒= Fall of paving

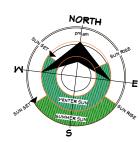

Kosir Residence Lot 14, DP 571567 Kahurangi Road, Knights Stream

Halswell, Canterbury TERRITORIAL AUTHORITY:

Christchurch City Council Residential Suburban Zone

SITE DATA (for zones upto & including):

Sub-soil Classification: E

Soil Classification REF GEO - TC2

Mind Zone: High

Earthquake Zone: 2

Exposure Zone: C

Climate Zone:

Rain Intensity (10%AEP): 53.7mm/hr

1.0kPa


Site Planning


JOB No:	97815	SALES:	Sonja			
LBP: C.	LBP: C.Mearne 101178					
DRAWN:	Katherine	DATE:	25/10/2022			
SCALE:	1:200	SHEET No.	3 OF 55			

HEIGHT RESTRICTION 8.0 m

50mm AAC Panels on

a drained cavity

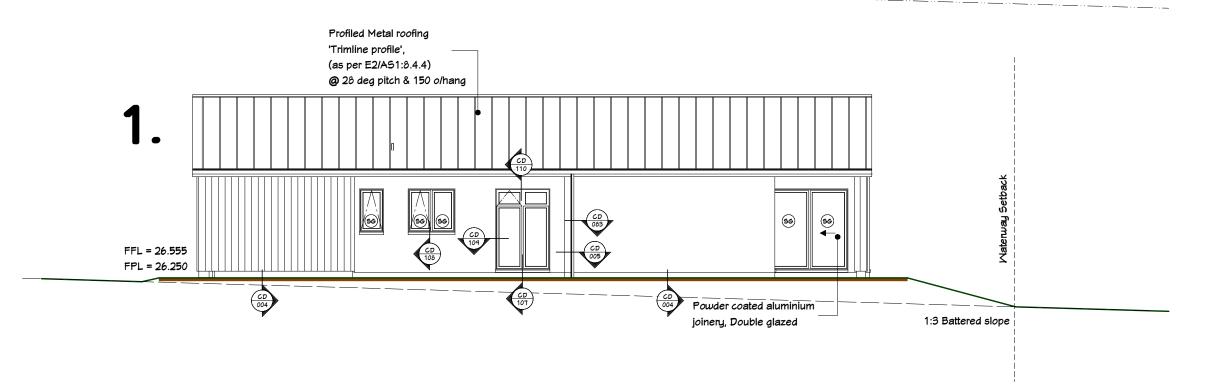

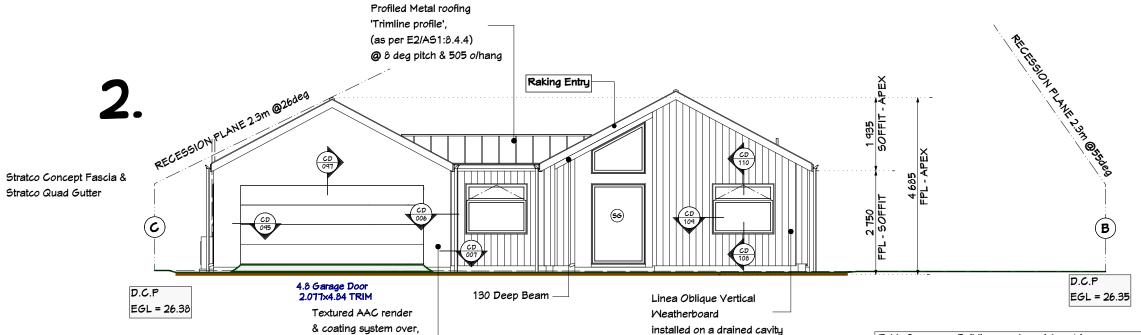

				5.P L = 2	6.35
Table 2 Building en				Κ	
Paragraph All Malls Risk	1 5. 1 < Sev		ure i		
Risk factor			High		Subtotals for each risk factor
Wind zone (per NZS 3604)	0	0	1	2	1
Number of storeus		1	2	4	0
Roof/wall intersection design		1	თ	5	3
Eaves width	0	1	2	5	2
Envelope complexity	0	1	3	6	1
Deck Design	0	2	4	6	0
	To	tal Ri	sk Sc	ore	7




NOTES:

 If windows & doors are shown upto soffit, window and door sizes are to be measured on site prior to the manufacture of those units.

FFL = Finished Floor Level

FGL = Finished Ground Level

FPL = Finished Platform Level EGL = Existing Ground Level

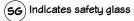

Safety Glazing

- All glazing is to be in accordance with the NZ Building Code Handbook and NZS.4223, Parts 1, 2, & 3 Code of Practice for Glazing in Buildings.
- All glazing panels to bathrooms and toilets to have safety glazing to the interior panel only
- All gazing to be confirmed by the manufacturer prior to construction

Callout of Details



(### = Reference to Cladding Details CD###

CLIENT:

Kosir Residence Lot 14, DP 571567 Kahurangi Road, Knights Stream

Halswell, Canterbury

TERRITORIAL AUTHORITY:

Christchurch City Council Residential Suburban Zone

SITE DATA (for zones upto & including):

Sub-soil Classification: E

Soil Classification REF GEO - TC2

Mind Zone:

Earthquake Zone: 2 Exposure Zone: C

Climate Zone:


Rain Intensity (10%AEP): 53.7mm/hr


Snowload: 1.0kPa

Elevations .1

High

JOB No: 9	7815	SALES:	S <i>o</i> nja
BP: C.M	Nearne 1011		
DRAWN:	Katherine		25/10/2022
SCALE:	1:100	SHEET No.	10 OF 55

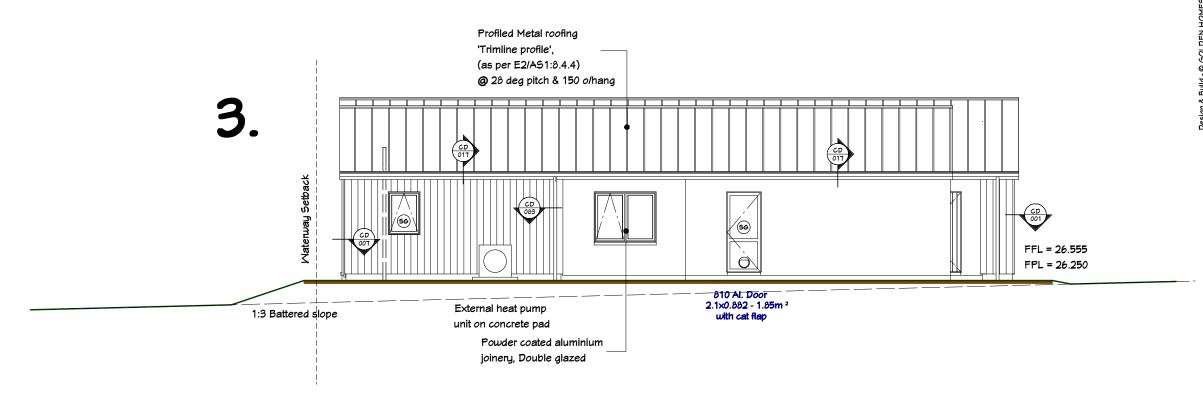

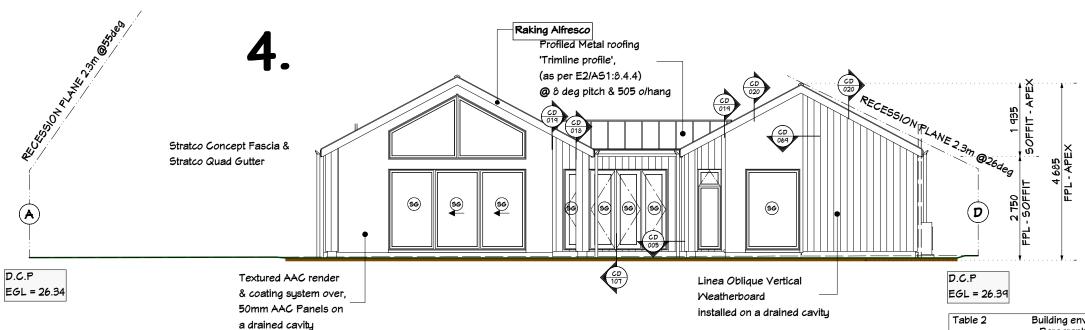

Building envelope risk matrix Paragraph 3.1.2. Figure 1 All Malls Risk Severity Risk factor Low Med High Very Subtotals for High each risk factor Wind zone (per NZS 3604) 2 4 0 3 5 3 Number of storeus Roof/wall intersection design 0 1
 0
 1
 2
 5
 2

 0
 1
 3
 6
 1

 0
 2
 4
 6
 0
 Eaves width Envelope complexity Deck Design Total Risk Score



NOTES:

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FFL = Finished Floor Level

FGL = Finished Ground Level

FPL = Finished Platform Level

EGL = Existing Ground Level

(56) Indicates safety glass

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Callout of Details



(### = Reference to Cladding Details CD###

CLIENT

Kosir Residence Lot 14, DP 571567 Kahurangi Road, Knights Stream

Halswell, Canterbury

TERRITORIAL AUTHORITY:

Christchurch City Council Residential Suburban Zone

SITE DATA (for zones upto & including):

Sub-soil Classification: E

Soil Classification REF GEO - TC2

Wind Zone: High Earthquake Zone: 2


Exposure Zone: C

Climate Zone: 3

Rain Intensity (10%AEP): 53.7mm/hr Snowload: 1.0kPa

Elevations .2

JOB No: 97815 | SALES: Sonja LBP: C.Wearne 101178 DRAWN: Katherine DATE: 25/10/2022 SCALE: 1:100 SHEET No. 11 OF 55

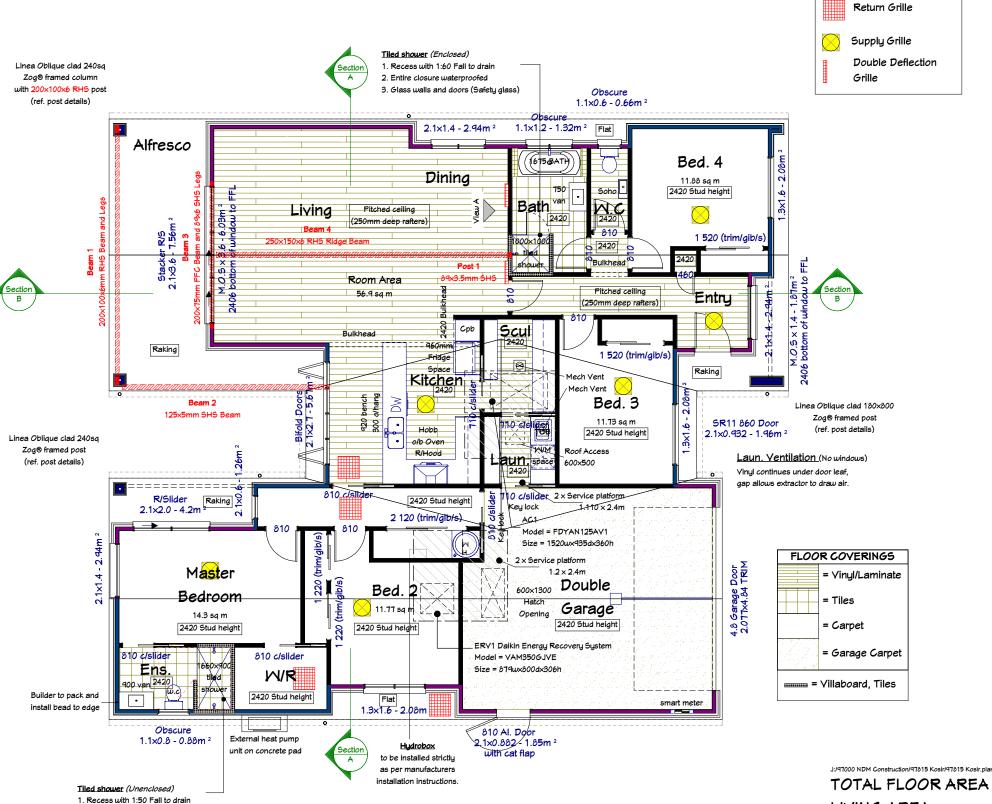

2. 1500 radius from rose (as shown)

Heating in Ceiling

LIVING AREA GARAGE AREA (excl. Laun) TOTAL ROOF AREA

APPROXIMATE Exterior wall perimeter APPROXIMATE Interior wall perimeter

APPROXIMATE Fascia & Gutter lineal meters

APPROXIMATE Barge lineal meters

Stud height - Refer to plan Interior door height - 1980mm

Truss heel height - 28° 250mm, 8° 239mm

GOLDSTAR HOMES®

NOTES:

89x41mm ZOG® framing

- Natural lighting is provided via glazing to 10% of floor areas for individual rooms
- Natural ventilation is provided via exterior openings of no less than 5% of floor area for individual rooms
- Internal and external walking surfaces to comply with NZBC D1/AS1 2.1.1 - 2.1.3, and Table 2
- External Access Routes surface is either; brushed concrete, exposed crushed aggregate concrete, profiled timber with the profile across the direction of travel, or be flooring selected by the client with a wet slip coefficient of no less than 0.4, refer to the specification for compliance procedure in such situations
- Where FFL is greater than 1.0m from FGL and the bottom of the opening is closer than 760mm to the FFL or a climbable fixture, a restrictor stay is to be fitted to limit the maximum opening so that a 100mm dia sphere cannot pass through it.
- All access routes are to be protected by dangerous projections as shown in D1/AS1,

ELEVATION GUIDE

CLIENT:

= 213.7saM

= 173.2saM

= 40.5sqM

= 77.7m

= 83.3m

= 52.2m

= 30.9m

= 256.7saM

Kosir Residence Lot 14, DP 571567 Kahurangi Road, Knights Stream

Halswell, Canterbury

TERRITORIAL AUTHORITY:

Christchurch City Council Residential Suburban Zone

SITE DATA (for zones upto & including):

Sub-soil Classification: E

Soil Classification REF GEO - TC2 Wind Zone: High

Earthquake Zone: 2 Exposure Zone: Climate Zone:

Rain Intensity (10%AEP): 53.7mm/hr Snowload: 1.0kPa

Floor Plan

JOB No: 97	815	SALES:	Sonja
LBP: C.M	earne 1011	78	
DRAWN:	Katherine	DATE:	25/10/202
SCALE:	1:100	SHEET No.	12 OF 5

